Please incorporate and prominently display the following contractor notice on all site plans and environmental plans. This notice is provided to the contractor and owner to advise them of their ultimate responsibility of compliance with Florida Accessibility Code (aka Handicap Code).

CONTRACTOR NOTICE 2020 (effective December 31, 2020)

The Contractor & Owner will be held accountable during construction for all site improvements. Compliance with Florida Statutes 553.5041 (F.S.), and the 2020 Florida Building Code, Accessibility, 7th Edition (FBC-A), is mandatory. If non-compliant at final inspection, contractor will be required to modify construction to comply with F.S. and FBC-A. The following items take precedence and supersede other site details on drawings:

- 1. ACCESSIBLE PARKING spaces shall be located on an accessible route no less than 44" wide so that users will not be compelled to walk or wheel behind parked vehicles except behind his or her own vehicle. §208.1 and §502.3, FBC-A and F.S. 553.5041.
- 2. ACCESSIBLE PARKING spaces and access aisles serving a particular building shall be located on the shortest accessible route from the accessible (H/C) parking to an accessible entrance. §208.3.1 FBC-A and F.S. 553.5041(5)(b).
- 3. ACCESSIBLE PARKING spaces shall be 12' wide, and outlined with blue paint. §502.2 and §502.6, FBC-A
- 4. ACCESS AISLES required adjacent to parking spaces shall be 5' wide with diagonal striping. §502., FBC-A
- 5. ACCESSIBLE PARKING and access aisles shall be level (not to exceed 1:48) on a stable, firm & slip resistant surface. Re:
- 6. ACCESSIBLE PARKING signs shall be FDOT approved and shall read 'PARKING BY DISABLED PERMIT ONLY' and shall indicate a \$250 fine for illegal use. Install signs a minimum 60" (inches) from the ground to the bottom of the sign(s). Re: §502.6
- 7. CURB RAMPS shall not exceed 1:12 slope, and curb ramp flares shall not exceed 1:10 slope. Curb ramps and flared sides shall not encroach upon parking spaces, access aisles, or vehicular traffic lanes. The counter slope of adjacent road surfaces & gutters shall not exceed 1:20. Re: §405.2, §406., FBC-A
- 8. CURB RAMPS shall have a landing with a minimum clear length of 36" shall be located at the top side of each curb ramp, a clear width at least as wide as the curb ramp (excluding flared sides) leading to it. Exception: for alterations, where there is no landing, curb ramp flares shall be provided, and shall not be steeper than 1:12 slope. Re: §406, FBC-A
- 9. ALL RAMPS with a rise greater than 6" shall provide edge protection complying with §405.9 FACBC. Ramps shall have 60" min level landings at the top & bottom. Re: §405.7. FBC-A.
- 10. ALL RAMPS with a rise greater than 6" shall have handrails on both sides with 12" horizontal extensions at the top & bottom of the ramp. Re: §1010.9 FBC-B (Florida Building Code - Building) and §505.10 FBC-A. 11. ACCESSIBLE ROUTES to "main entry" from an accessible parking space, and from the "public way", shall not exceed 1:20 slope (unless ramps, handrails with proper extensions are provided) with cross slope not in excess of 1:48. Re: §206, §402 and
- 12. *Connect buildings within the same site with an accessible route which shall not exceed 1:20 slope (unless ramps and handrails are provided) and a maximum cross slope of 1:48. Re: §206 FBC-A.
- * EXCEPTION: An accessible route shall not be required between accessible buildings, accessible facilities, accessible elements, and accessible spaces if the only means of access between them is a vehicular way not providing pedestrian access. Re:

CITY OF TALLAHASSEE 435 N MACOMB STREET

TALLAHASSEE, FLORIDA 32301

2602 JACKSON BLUFF ROAD TALLAHASSEE, FLORIDA 32304

COMCAST BUSINESS SERVICES

(850) 891-5108

(754) 221-4844

GOVERNMENT/UTILITY CONTACTS

FIRE AUTHORITY

CONTACT: GARY DONALDSON

CONTACT: JOSHUA LOGAN, P.E.

STORMWATER DEPARTMENT

PLANNING AND ZONING AUTHORITY

CONTACT: LANCE JACOBSON

CONTACT: ROBERT TREDIK

(CITY OF TALLAHASSEE)

BUILDING DEPARTMENT

ELECTRIC COMPANY

CONTACT: TINA DROSE

CONTACT: PAUL CHANG COMMUNICATION COMPANY

CONTACT: RAUL VELAZQUEZ

GAS COMPANY


UTILITIES DEPARTMENT

TYPE 'A' SITE PLAN **FOR**



RESTAURANT #0734 1917 WEST TENNESSEE ST CITY OF TALLAHASSEE LEON COUNTY, FL **SECTION 21 TOWNSHIP 1N RANGE 1W**

(850) 891-7179 CITY OF TALLAHASSEE 408 N ADAMS STREET TALLAHASSEE, FLORIDA 32301 (850) 8916167 MANAGEMENT DISTRICT 81 WATER MANAGEMENT DRIVE HAVANNA, FLORIDA 32333 (850) 539-5999 CITY OF TALLAHASSEE 435 N MACOMB STREET TALLAHASSEE, FLORIDA 32301 CONTACT: MATTHEW HENNESSY, P.E. | (850) 891-7179 PROJECT LOCATION CITY OF TALLAHASSEE 435 N MACOMB STREET TALLAHASSEE, FLORIDA 32301 **LEON COUNTY** (850) 891-7166 CITY OF TALLAHASSEE 435 N MACOMB STREET TALLAHASSEE, FLORIDA 32301 (850) 891-7071 CITY OF TALLAHASSEE UTILITIES 435 N MACOMB STREET TALLAHASSEE, FLORIDA 32301 (850) 891-5016 CITY OF TALLAHASSEE GAS UTILITY

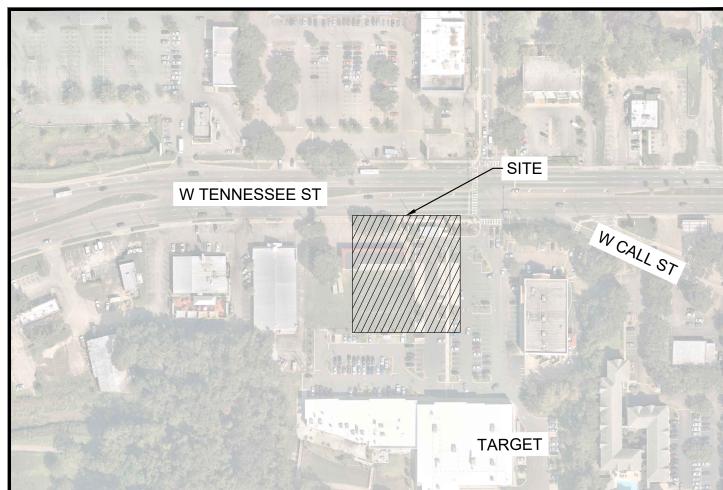

TARGET	
SITE LOCATION MAP (NOT TO SCALE)	

1. IF REPRODUCED, THE SCALES SHOWN ON THESE PLANS ARE BASED ON A 22" X 34" SHEET.

1 OF 2 **BOUNDARY & TOPO SURVEY ALTA** 10-28-2021 NSPS LAND TITLE SURVEY **BOUNDARY & TOPO SURVEY ALTA** 2 OF 2 10-28-2021 NSPS LAND TITLE SURVEY C2.0 GENERAL NOTES 02-03-2022 **EROSION CONTROL PLAN** C3.0 SUBMITTED C3.1 **EROSION CONTROL DETAILS SUBMITTED** C4.0 DEMOLITION PLAN 02-03-2022 C5.0 SITE KEYNOTE PLAN 02-03-2022 C5.1 DIMENSION CONTROL PLAN 02-03-2022 C5.2 STRIPING AND SIGNAGE PLAN 02-03-2022 C5.3 PAVING AND JOINT LAYOUT PLAN NOT SUBMITTED CIRCULATION PLAN C5.4 02-03-2022 VEHICLE STACKING AND C5.5 CIRCULATION PLAN 02-03-2022 C6.0 **GRADING PLAN** 02-03-2022 C6.1 DRAINAGE PLAN 02-03-2022 C6.2 DRAINAGE DETAILS SUBMITTED DRAINAGE DETAILS **SUBMITTED** C7.0 UTILITY PLAN 02-03-2022 **CONSTRUCTION DETAILS**

INDEX OF SHEETS

DATE | REVISION

02-03-2022

02-03-2022

02-03-2022

SUBMITTED

DESCRIPTION

COVER SHEET

SHEET NO.

PLANS SUBMITTAL/REVIEW LOG

LP1.0

LP1.1

NO.	NO. DESCRIPTION		MILESTONE
1	80% ENTITLEMENT SET	10/06/2021	NOT FOR CONSTRUCTION
2	SITE PLAN REVIEW	10/28/2021	FOR REVIEW
3	2nd SITE PLAN REVIEW	02/03/2022	FOR REVIEW

CONCEPTUAL LANDSCAPE PLAN

LANDSCAPE DETAILS

Restaurant:

Raising Cane's Restaurant #0734 1917 West Tennessee St. Tallahassee, FL P4E-AV [B] M

Designer's Information:

6767 Perkins Road, Suite 200 Baton Rouge, Louisiana 70808 Telephone: 225 769-0546 www.csrsinc.com

Prototype Phase:	2021-1.0 P4E-A
Project Issue Date:	02-03-202
CSRS Project Manager:	·

FOR REVIEW

619 CENTENNIAL BLVD, STE 200, TALLAHASSEE, FL 32308 PHONE: 850-553-3500



#	Date	Description

COVER SHEET

CALL 2 WORKING DAYS BEFORE YOU DIG IT'S THE LAW! Know what's **below**. **DIAL 811** Call before you dig.

PROJECT DATUM NAVD 88

SUNSHINE STATE ONE CALL OF FLORIDA, INC.

Sheet Number:

ENGINEER

2619 CENTENNIAL BOULEVARD, SUITE 200 TALLAHASSEE, FLORIDA 32308 PH. (850)-553-3500 CONTACT: KELSEY LEWIS, P.E KELSEY.LEWIS@KIMLEY-HORN.COM

OWNER/DEVELOPER

RAISING CANES RESTAURANT, LLC 6800 BISHOP ROAD PLANO, TX 75024 (P) 347 772-5858 CONTACT: REBECCA MUNOZ RMUNOZ@PMSUPPORTSOLUTIONS.COM

ARCHITECT CSRS

8555 United Plaza Boulevard, Baton Rouge, LA 70809 (P) 469 899-3074 CONTACT: JOSE HERNANDEZ JOSE.HERNANDEZ@CSRSINC.COM

FEBRUARY 2022

GENERAL CONSTRUCTION NOTES

- 1. THE CONTRACTOR AND SUBCONTRACTORS SHALL OBTAIN A COPY OF THE FLORIDA DEPARTMENT OF TRANSPORTATION "STANDARD SPECIFICATIONS FOR ROAD AND BRIDGE CONSTRUCTION" (LATEST EDITION) AND BECOME FAMILIAR WITH THE CONTENTS PRIOR TO COMMENCING WORK, AND, UNLESS OTHERWISE NOTED, ALL WORK SHALL CONFORM AS APPLICABLE TO THESE STANDARDS AND SPECIFICATIONS.
- 2. THE CONTRACTOR SHALL BE RESPONSIBLE FOR FURNISHING ALL MATERIAL AND LABOR TO CONSTRUCT THE FACILITY AS SHOWN AND DESCRIBED IN THE CONSTRUCTION DOCUMENTS IN ACCORDANCE WITH THE APPROPRIATE APPROVING AUTHORITIES, SPECIFICATIONS AND REQUIREMENTS. CONTRACTOR SHALL CLEAR AND GRUB ALL AREAS UNLESS OTHERWISE INDICATED, REMOVING TREES, STUMPS, ROOTS, MUCK, EXISTING PAVEMENT AND ALL OTHER **DELETERIOUS MATERIAL**
- 3. EXISTING UTILITIES SHOWN ARE LOCATED ACCORDING TO THE INFORMATION AVAILABLE TO THE ENGINEER AT THE TIME OF THE TOPOGRAPHIC SURVEY AND HAVE NOT BEEN INDEPENDENTLY VERIFIED BY THE OWNER OR THE ENGINEER. GUARANTEE IS NOT MADE THAT ALL EXISTING UNDERGROUND UTILITIES ARE SHOWN OR THAT THE LOCATION OF THOSE SHOWN ARE ENTIRELY ACCURATE. FINDING THE ACTUAL LOCATION OF ANY EXISTING UTILITIES IS THE CONTRACTOR'S RESPONSIBILITY AND SHALL BE DONE BEFORE COMMENCING ANY WORK IN THE VICINITY. FURTHERMORE, THE CONTRACTOR SHALL BE FULLY RESPONSIBLE FOR ANY AND ALL DAMAGES DUE TO THE CONTRACTOR'S FAILURE TO EXACTLY LOCATE AND PRESERVE ANY AND ALL UNDERGROUND UTILITIES. THE OWNER OR ENGINEER WILL ASSUME NO LIABILITY FOR ANY DAMAGES SUSTAINED OR COST INCURRED BECAUSE OF THE OPERATIONS IN THE VICINITY OF EXISTING UTILITIES OR STRUCTURES, NOR FOR TEMPORARY BRACING AND SHORING OF SAME. IF IT IS NECESSARY TO SHORE, BRACE, SWING OR RELOCATE A UTILITY, THE UTILITY COMPANY OR DEPARTMENT AFFECTED SHALL BE CONTACTED AND THEIR PERMISSION OBTAINED REGARDING THE METHOD TO USE FOR SUCH WORK.
- 4. IT IS THE CONTRACTOR'S RESPONSIBILITY TO CONTACT THE VARIOUS UTILITY COMPANIES WHICH MAY HAVE BURIED OR AERIAL UTILITIES WITHIN OR NEAR THE CONSTRUCTION AREA BEFORE COMMENCING WORK. THE CONTRACTOR SHALL PROVIDE 48 HOURS MINIMUM NOTICE TO ALL UTILITY COMPANIES PRIOR TO BEGINNING CONSTRUCTION. AN APPROXIMATE LIST OF THE UTILITY COMPANIES WHICH THE CONTRACTOR MUST CALL BEFORE COMMENCING WORK IS PROVIDED ON THE COVER SHEET OF THESE CONSTRUCTION PLANS. THIS LIST SERVES AS A GUIDE ONLY AND IS NOT INTENDED TO LIMIT THE UTILITY COMPANIES WHICH THE CONTRACTOR MAY WISH TO NOTIFY.
- 5. THE CONTRACTOR SHALL BE RESPONSIBLE FOR OBTAINING ALL REQUIRED CONSTRUCTION PERMITS AND BONDS IF REQUIRED PRIOR TO CONSTRUCTION.
- 6. THE CONTRACTOR SHALL HAVE AVAILABLE AT THE JOB SITE AT ALL TIMES ONE COPY OF THE CONSTRUCTION DOCUMENTS INCLUDING PLANS, SPECIFICATIONS, GEOTECHNICAL REPORT AND SPECIAL CONDITIONS AND COPIES OF ANY REQUIRED CONSTRUCTION PERMITS.
- 7. ANY DISCREPANCIES ON THE DRAWINGS SHALL BE IMMEDIATELY BROUGHT TO THE ATTENTION OF THE OWNER AND ENGINEER BEFORE COMMENCING WORK. NO FIELD CHANGES OR DEVIATIONS FROM DESIGN ARE TO BE MADE WITHOUT PRIOR APPROVAL OF THE OWNER AND NOTIFICATION TO THE ENGINEER.
- 8. ALL COPIES OF COMPACTION, CONCRETE AND OTHER REQUIRED TEST RESULTS ARE TO BE SENT TO THE OWNER AND DESIGN ENGINEER OF RECORD DIRECTLY FROM THE TESTING AGENCY.
- 9. THE CONTRACTOR SHALL BE RESPONSIBLE FOR SUBMITTING TO THE ENGINEER A CERTIFIED RECORD SURVEY SIGNED AND SEALED BY A PROFESSIONAL LAND SURVEYOR REGISTERED IN THE STATE OF FLORIDA DEPICTING THE ACTUAL FIELD LOCATION OF ALL CONSTRUCTED IMPROVEMENTS THAT ARE REQUIRED BY THE JURISDICTIONAL AGENCIES FOR THE CERTIFICATION PROCESS. ALL SURVEY COSTS WILL BE THE CONTRACTORS RESPONSIBILITY.
- 10. THE CONTRACTOR SHALL BE RESPONSIBLE FOR DOCUMENTING AND MAINTAINING AS-BUILT INFORMATION WHICH SHALL BE RECORDED AS CONSTRUCTION PROGRESSES OR AT THE COMPLETION OF APPROPRIATE CONSTRUCTION INTERVALS AND SHALL BE RESPONSIBLE FOR PROVIDING AS-BUILT DRAWINGS TO THE OWNER FOR THE PURPOSE OF CERTIFICATION TO JURISDICTIONAL AGENCIES AS REQUIRED. ALL AS-BUILT DATA SHALL BE COLLECTED BY A STATE OF FLORIDA PROFESSIONAL LAND SURVEYOR WHOSE SERVICES ARE ENGAGED BY THE CONTRACTOR.
- 11. ANY WELLS DISCOVERED ON SITE THAT WILL HAVE NO USE MUST BE PLUGGED BY A LICENSED WELL DRILLING CONTRACTOR IN A MANNER APPROVED BY ALL JURISDICTIONAL AGENCIES. CONTRACTOR SHALL BE RESPONSIBLE FOR OBTAINING ANY WELL ABANDONMENT PERMITS
- 12. ANY WELL DISCOVERED DURING EARTH MOVING OR EXCAVATION SHALL BE REPORTED TO THE APPROPRIATE JURISDICTIONAL AGENCIES WITHIN 24 HOURS AFTER DISCOVERY IS MADE.
- 13. THE CONTRACTOR SHALL BE RESPONSIBLE FOR VERIFYING THAT THE PROPOSED IMPROVEMENTS SHOWN ON THE PLANS DO NOT CONFLICT WITH ANY KNOWN EXISTING OR OTHER PROPOSED IMPROVEMENTS. IF ANY CONFLICTS ARE DISCOVERED, THE CONTRACTOR SHALL NOTIFY THE OWNER PRIOR TO INSTALLATION OF ANY PORTION OF THE SITE WORK THAT WOULD BE AFFECTED. FAILURE TO NOTIFY OWNER OF AN IDENTIFIABLE CONFLICT PRIOR TO PROCEEDING WITH INSTALLATION RELIEVES OWNER OF ANY OBLIGATION TO PAY FOR A RELATED CHANGE ORDER.
- 14. ANY CONSTRUCTION ADJACENT TO A WETLAND AREA SHALL BE PERFORMED FROM THE UPLAND SIDE OF THE AREA. CONSTRUCTION ENCROACHMENT INTO A WETLAND AREA IS NOT ALLOWED UNLESS PERMITTED BY THE JURISDICTIONAL AGENCY.
- 15. TRAFFIC CONTROL SHALL BE IN ACCORDANCE WITH THE CURRENT FDOT DESIGN STANDARD INDEX (SERIES 600) AND THE MANUAL ON UNIFORM TRAFFIC CONTROL DEVICES.
- 16. CONTRACTOR SHALL PHOTOGRAPHICALLY DOCUMENT THE PRE-CONSTRUCTION CONDITIONS ON-SITE AND WITHIN THE SURROUNDING OFF-SITE AREAS WITHIN THE TARGET PARKING LOT PRIOR TO THE START OF CONSTRUCTION.

DEMOLITION NOTES

- . ALL MATERIAL REMOVED FROM THIS SITE BY THE CONTRACTOR SHALL BE DISPOSED OF BY THE CONTRACTOR IN A LEGAL MANNER.
- 2. REFER TO THE TOPOGRAPHIC SURVEY FOR ADDITIONAL DETAILS OF EXISTING STRUCTURES, ETC., LOCATED WITHIN THE PROJECT SITE. UNLESS OTHERWISE NOTED, ALL EXISTING BUILDINGS, STRUCTURES, SLABS, CONCRETE, ASPHALT, DEBRIS PILES, SIGNS, AND ALL APPURTENANCES ARE TO BE REMOVED FROM THE SITE BY THE CONTRACTOR AND PROPERLY DISPOSED OF IN A LEGAL MANNER AS PART OF THIS CONTRACT. SOME ITEMS TO BE REMOVED MAY NOT BE DEPICTED ON THE TOPOGRAPHIC SURVEY. IT IS THE CONTRACTOR'S RESPONSIBILITY TO VISIT THE SITE AND DETERMINE THE FULL EXTENT OF ITEMS TO BE REMOVED. IF ANY ITEMS ARE IN QUESTION, THE CONTRACTOR SHALL CONTACT THE OWNER PRIOR TO REMOVAL OF SAID ITEMS.
- 3. THE DEVELOPER SHALL REPAIR ANY DAMAGE TO THE RIGHT-OF-WAY CAUSED DURING CONSTRUCTION, SUCH AS REPLACE ANY CURB AND GUTTER AND OTHER EXISTING INFRASTRUCTURE THAT IS DAMAGED DUE TO THE DEVELOPMENT CONSTRUCTION.
- 4. THE CONTRACTOR SHALL REFER TO THE DEMOLITION PLAN AND TREE INVENTORY PLAN FOR DEMOLITION/PRESERVATION OF EXISTING TREES. ALL TREES NOT SPECIFICALLY SHOWN TO BE PRESERVED OR RELOCATED SHALL BE REMOVED AS A PART OF THIS CONTRACT. TREE PROTECTION FENCING SHALL BE INSTALLED PRIOR TO ANY DEMOLITION.
- 5. CONTRACTOR SHALL ADJUST GRADE OF ANY EXISTING UTILITIES TO REMAIN.
- 6. CONTRACTOR IS REQUIRED TO OBTAIN ALL DEMOLITION PERMITS

RECORD DRAWINGS

1. CONTRACTOR SHALL PROVIDE TO THE ENGINEER AND OWNER A MINIMUM OF 10 HARD COPIES OF A PAVING, GRADING AND DRAINAGE RECORD DRAWING AND A SEPARATE UTILITY RECORD DRAWING, AS WELL AS BOTH IN AUTOCAD 2007 OR LATER, BOTH PREPARED BY A FLORIDA REGISTERED SURVEYOR. THE RECORD DRAWINGS SHALL VERIFY ALL DESIGN INFORMATION INCLUDED ON THE DESIGN PLANS OF THE SAME NAME.

PAVING, GRADING AND DRAINAGE NOTES

- ALL PAVING, CONSTRUCTION, MATERIALS, AND WORKMANSHIP WITHIN JURISDICTION'S RIGHT-OF-WAY SHALL BE IN ACCORDANCE WITH LOCAL OR COUNTY SPECIFICATIONS AND STANDARDS (LATEST EDITION) OR FDOT SPECIFICATIONS AND STANDARDS (LATEST EDITION) IF NOT COVERED BY LOCAL OR COUNTY REGULATIONS.
- 2. ALL UNPAVED AREAS IN EXISTING RIGHTS-OF-WAY DISTURBED BY CONSTRUCTION SHALL BE REGRADED AND SODDED.
- 3. TRAFFIC CONTROL ON ALL FDOT, LOCAL AND COUNTY RIGHTS-OF-WAY SHALL MEET THE REQUIREMENTS OF THE MANUAL OF UNIFORM TRAFFIC CONTROL DEVICES (U.S. DOT/FHA) AND THE REQUIREMENTS OF THE STATE AND ANY LOCAL AGENCY HAVING JURISDICTION. IN THE EVENT THAT THE CONTRACT DOCUMENTS AND THE JURISDICTIONAL AGENCY REQUIREMENTS ARE NOT IN AGREEMENT, THE MOST STRINGENT SHALL GOVERN.
- 4. THE CONTRACTOR SHALL GRADE THE SITE TO THE ELEVATIONS INDICATED AND SHALL REGRADE WASHOUTS WHERE THEY OCCUR AFTER EVERY RAINFALL UNTIL A GRASS STAND IS WELL ESTABLISHED OR ADEQUATE STABILIZATION OCCURS.
- 5. ALL OPEN AREAS WITHIN THE PROJECT SITE SHALL BE SODDED UNLESS INDICATED OTHERWISE ON THE LANDSCAPE PLAN.
- 6. ALL AREAS INDICATED AS PAVEMENT SHALL BE CONSTRUCTED IN ACCORDANCE WITH THE TYPICAL PAVEMENT SECTIONS AS INDICATED ON THE DRAWINGS.
- 7. WHERE EXISTING PAVEMENT IS INDICATED TO BE REMOVED AND REPLACED. THE CONTRACTOR SHALL SAW CUT A MINIMUM 2" DEEP FOR A SMOOTH AND STRAIGHT JOINT AND REPLACE THE PAVEMENT WITH THE SAME TYPE AND DEPTH OF MATERIAL AS EXISTING OR AS INDICATED.
- 8. WHERE NEW PAVEMENT MEETS THE EXISTING PAVEMENT, THE CONTRACTOR SHALL SAW CUT THE EXISTING PAVEMENT A MINIMUM 2" DEEP FOR A SMOOTH AND STRAIGHT JOINT AND MATCH THE EXISTING PAVEMENT ELEVATION WITH THE PROPOSED PAVEMENT UNLESS OTHERWISE INDICATED.
- 9. THE CONTRACTOR SHALL INSTALL FILTER FABRIC OVER ALL DRAINAGE STRUCTURES FOR THE DURATION OF CONSTRUCTION AND UNTIL ACCEPTANCE OF THE PROJECT BY THE OWNER. ALL DRAINAGE STRUCTURES SHALL BE CLEANED OF DEBRIS AS REQUIRED DURING AND AT THE END 0.5" RAINFALL EVENT, AND CLEANED AND REPAIRED IN ACCORDANCE WITH THE FOLLOWING: OF CONSTRUCTION TO PROVIDE POSITIVE DRAINAGE FLOWS.
- 10. IF DEWATERING IS REQUIRED. THE CONTRACTOR SHALL OBTAIN ANY APPLICABLE REQUIRED PERMITS. THE CONTRACTOR IS TO COORDINATE WITH THE OWNER AND THE DESIGN ENGINEER PRIOR TO ANY EXCAVATION.
- 11. STRIP TOPSOIL AND ORGANIC MATTER FROM ALL AREAS OF THE SITE AS REQUIRED. IN SOME CASES TOPSOIL MAY BE STOCKPILED ON SITE FOR PLACEMENT WITHIN LANDSCAPED AREAS BUT ONLY AS DIRECTED BY THE OWNER.
- 12. FIELD DENSITY TESTS SHALL BE TAKEN AT INTERVALS IN ACCORDANCE WITH THE LOCAL JURISDICTIONAL AGENCY OR TO FDOT STANDARDS. IN THE EVENT THAT THE CONTRACT DOCUMENTS AND THE JURISDICTIONAL AGENCY REQUIREMENTS ARE NOT IN AGREEMENT, THE MOST STRINGENT SHALL GOVERN.
- 13. ALL SLOPES AND AREAS DISTURBED BY CONSTRUCTION SHALL BE GRADED AS PER PLANS. THE AREAS SHALL THEN BE SODDED OR SEEDED AS SPECIFIED IN THE PLANS, FERTILIZED, MULCHED. 5. WATERED AND MAINTAINED UNTIL HARDY GRASS GROWTH IS ESTABLISHED IN ALL AREAS. ANY AREAS DISTURBED FOR ANY REASON PRIOR TO FINAL ACCEPTANCE OF THE JOB SHALL BE CORRECTED BY THE CONTRACTOR AT NO ADDITIONAL COST TO THE OWNER. ALL EARTHEN AREAS WILL BE SODDED OR SEEDED AND MULCHED AS SHOWN ON THE LANDSCAPING PLAN.
- 14. ALL CUT OR FILL SLOPES SHALL BE 3 (HORIZONTAL) :1 (VERTICAL) OR FLATTER UNLESS OTHERWISE SHOWN.
- 15. THE CONTRACTOR SHALL BE RESPONSIBLE FOR THE CONTROL OF DUST AND DIRT RISING AND SCATTERING IN THE AIR DURING CONSTRUCTION AND SHALL PROVIDE WATER SPRINKLING OR OTHER SUITABLE METHODS OF CONTROL. THE CONTRACTOR SHALL COMPLY WITH ALL GOVERNING REGULATIONS PERTAINING TO ENVIRONMENTAL PROTECTION.
- 16. THE CONTRACTOR SHALL TAKE ALL REQUIRED MEASURES TO CONTROL TURBIDITY, INCLUDING BUT NOT LIMITED TO THE INSTALLATION OF TURBIDITY BARRIERS AT ALL LOCATIONS WHERE THE POSSIBILITY OF TRANSFERRING SUSPENDED SOLIDS INTO THE RECEIVING WATER BODY EXISTS DUE TO THE PROPOSED WORK. TURBIDITY BARRIERS MUST BE MAINTAINED IN EFFECTIVE CONDITION AT ALL LOCATIONS UNTIL CONSTRUCTION IS COMPLETED AND DISTURBED SOIL AREAS ARE STABILIZED. THEREAFTER, THE CONTRACTOR MUST REMOVE THE BARRIERS, AT NO TIME SHALL THERE BE ANY OFF-SITE DISCHARGE WHICH VIOLATES THE WATER QUALITY STANDARDS IN CHAPTER 17-302, FLORIDA ADMINISTRATIVE CODE.
- 17. SOD, WHERE CALLED FOR, MUST BE INSTALLED AND MAINTAINED ON EXPOSED SLOPES WITHIN 48 HOURS OF COMPLETING FINAL GRADING, AND AT ANY OTHER TIME AS NECESSARY. TO PREVENT EROSION, SEDIMENTATION OR TURBID DISCHARGES.
- 18. THE CONTRACTOR MUST REVIEW AND MAINTAIN A COPY OF THE ENVIRONMENTAL RESOURCE PERMIT COMPLETE WITH ALL CONDITIONS, ATTACHMENTS, EXHIBITS, AND PERMIT MODIFICATIONS IN GOOD CONDITION AT THE CONSTRUCTION SITE. THE COMPLETE PERMIT MUST BE AVAILABLE FOR REVIEW UPON REQUEST BY WATER MANAGEMENT DISTRICT REPRESENTATIVES.
- 19. THE CONTRACTOR SHALL ENSURE THAT ISLAND PLANTING AREAS AND OTHER PLANTING AREAS ARE NOT COMPACTED AND DO NOT CONTAIN ROAD BASE MATERIALS. THE CONTRACTOR SHALL ALSO EXCAVATE AND REMOVE ALL UNDESIRABLE MATERIAL FROM ALL AREAS ON THE SITE TO BE PLANTED AND PROPERLY DISPOSED OF IN A LEGAL MANNER.
- 20. THE CONTRACTOR SHALL INSTALL ALL UNDERGROUND STORM WATER PIPING PER MANUFACTURER'S RECOMMENDATIONS.

SITE PLAN NOTES

- 1. ALL DIMENSIONS SHOWN ARE TO THE FACE OF CURB UNLESS OTHERWISE NOTED.
- 2. ALL CURB SHALL HAVE A 3' TRANSITION AT THE BEGINNING AND ENDING POINTS WHEN NOT CONNECTING TO TYPE 'F' CURB AND GUTTER.
- 3. ALL CURB RAMPS AND SIDEWALKS ENTERING PARKING OR TRAVEL WAYS SHALL HAVE DETECTABLE WARNING SURFACES 2' DEEP AND THE WIDTH OF THE SIDEWALK. DETECTABLE WARNING SURFACE SHALL BE YELLOW ARMORTILE (OR APPROVED EQUAL) SURFACE APPLIED MATS UNLESS OTHERWISE SPECIFIED.
- 4. THE APPROVAL OF THE SITE PLAN DOES NOT ALLOW THE LOCATION OF THE SIGNS. THE SIGN VENDOR SHALL SUBMIT A SEPARATE SIGN PERMIT TO THE CITY OF TALLAHASSEE THAT MUST BE APPROVED BEFORE THE SIGNS ARE PLACED.
- 5. ALL RETAINING WALLS EQUAL TO OR GREATER THAN 24" HEIGHT WILL REQUIRE A SEPERATE BUILDING PERMIT.
- 6. CONTRACTOR SHALL REPAIR ANY DAMAGE TO THE R.O.W. CAUSED DURING CONSTRUCTION. CONTRACTOR SHALL PHOTOGRAPHICALLY DOCUMENT THE PRE-CONSTRUCTION CONDITIONS.

- 7. PER SECTION 10-284.2(A)(4) OF THE TALLAHASSEE LAND DEVELOPMENT CODE (TLDC) STORIES MAY NOT EXCEED 14 FEET IN HEIGHT FROM FINISHED FLOOR TO FINISHED CEILING, EXCEPT FOR A FIRST FLOOR NON-RESIDENTIAL USE, WHICH SHALL BE A MINIMUM OF 12 FEET WITH A MAXIMUM OF 25 FEET. PLEASE SEE ARCH. PLANS FOR STORY HEIGHT DETAILS.
- PER SECTION 10-284.2(A)(8) OF THE TLDC ALL BUILDING ELEVATIONS ADJACENT TO PUBLIC RIGHTS OF WAY OR PEDESTRIAN WAYS SHALL PROVIDE TRANSPARENCY AT EYE LEVEL. BETWEEN THREE AND EIGHT FEET ABOVE FINISHED GRADE, IN ACCORDANCE WITH THE FOLLOWING MINIMUM PERCENTAGES. IN ALL STRUCTURES, A MINIMUM OF 15% TRANSPARENCY SHALL BE PROVIDED ABOVE THE FIRST STORY OF FACADES ADJACENT TO THE PUBLIC RIGHTS OF WAY. REFLECTIVE GLASS IS PROHIBITED. PLEASE SEE ARCH. PLANS FOR TRANSPARENCY DETAILS.
 - NON-RESIDENTAIL FRONTAGE - 60% SIDE ELEVATIONS - 30%
- THE OSHA POWER LINE SAFETY RULE 1926.1408 REQUIRES A MINIMUM WORKING SPACE OF 10 FEET FROM OVERHEAD ELECTRIC LINES. THIS 10 FEET IS NOT FROM THE BUILDING BUT FROM THE SCAFFOLDING AND EQUIPMENT USED DURING CONSTRUCTION. ADDITIONALLY, CRANES ARE REQUIRED TO HAVE A TWENTY FOOT CLEARANCE FROM POWER LINES.
- 10. IF A WELL OR SINK HOLE IS DISCOVERED DISCOVERED ON PROPERTY PLEASE NOTIFY AQUIFER PROTECTION AT 850-363-0961 (CORY SEAY)
- 11. VIEW OF PEDESTRIANS SHALL NOT BE OBSCURED ALONG THE VEHICLE ACCESS ON THE PRIMARY FRONTAGE.
- 12. SECTION 10-284.2(A)(7) OUTDOOR SPACE, PORCHES, STOOPS, BALCONIES, AND TERRACES SHALL BE DESIGNED AS USABLE SPACE, MEANING THE AREA SHALL BE A MINIMUM 4 FT IN WIDTH AND DEPTH. THIS REQUIREMENT WILL BE VERIFIED AT THE TIME OF BUILDING PERMIT.
- 13. ALL NATIVE SPECIES WILL BE USED FOR REQUIRED PLANTINGS. THE TYPE AND NUMBER OF PLANTINGS WILL BE APPROVED BY GROWTH MANAGEMENT STAFF AT THE TIME OF **ENVIRONMENTAL PERMITTING.**
- 14. SITE IS SUBJECT TO THE TLDC SITE LIGHTING STANDARDS OF SEC. 10-427

MAINTENANCE

ALL MEASURES STATED ON THE EROSION AND SEDIMENT CONTROL PLAN, AND IN THE STORM WATER POLLUTION PREVENTION PLAN, SHALL BE MAINTAINED IN FULLY FUNCTIONAL CONDITION UNTIL NO LONGER REQUIRED FOR A COMPLETED PHASE OF WORK OR FINAL STABILIZATION OF THE 11. RUBBISH, TRASH, GARBAGE, LITTER, OR OTHER SUCH MATERIALS SHALL BE DEPOSITED INTO SITE. ALL EROSION AND SEDIMENTATION CONTROL MEASURES SHALL BE CHECKED BY A QUALIFIED PERSON AT LEAST ONCE EVERY SEVEN CALENDAR DAYS AND WITHIN 24 HOURS OF THE END OF A

- 1. INLET PROTECTION DEVICES AND BARRIERS SHALL BE REPAIRED OR REPLACED IF THEY SHOW SIGNS OF UNDERMINING. OR DETERIORATION.
- 2. ALL SEEDED AREAS SHALL BE CHECKED REGULARLY TO SEE THAT A GOOD STAND IS MAINTAINED. AREAS SHOULD BE FERTILIZED, WATERED AND RESEEDED AS NEEDED. FOR MAINTENANCE REQUIREMENTS REFER TO SECTION 981 OF THE STANDARD SPECIFICATIONS.
- SILT FENCES SHALL BE REPAIRED TO THEIR ORIGINAL CONDITIONS IF DAMAGED. SEDIMENT SHALL BE REMOVED FROM THE SILT FENCES WHEN IT REACHES ONE-HALF THE HEIGHT OF THE SILT FENCE.
- THE CONSTRUCTION ENTRANCES SHALL BE MAINTAINED IN A CONDITION WHICH WILL PREVENT TRACKING OR FLOW OF MUD ONTO PUBLIC RIGHTS-OF-WAY. THIS MAY REQUIRE PERIODIC TOP DRESSING OF THE CONSTRUCTION ENTRANCES AS CONDITIONS DEMAND.
- THE TEMPORARY PARKING AND STORAGE AREA SHALL BE KEPT IN GOOD CONDITION (SUITABLE FOR PARKING AND STORAGE). THIS MAY REQUIRE PERIODIC TOP DRESSING OF THE TEMPORARY PARKING AS CONDITIONS DEMAND.
- 6. OUTLET STRUCTURES IN THE SEDIMENTATION BASINS SHALL BE MAINTAINED IN OPERATIONAL CONDITIONS AT ALL TIMES. SEDIMENT SHALL BE REMOVED FROM SEDIMENT BASINS OR TRAPS WHEN THE DESIGN CAPACITY HAS BEEN REDUCED BY 55 CUBIC YARDS / ACRE.
- . ALL MAINTENANCE OPERATIONS SHALL BE DONE IN A TIMELY MANNER BUT IN NO CASE LATER THAN 2 CALENDAR DAYS FOLLOWING THE INSPECTION.

WATER AND SEWER UTILITY NOTES

- 1. THE CONTRACTOR SHALL CONSTRUCT GRAVITY SEWER LATERALS, MANHOLES GRAVITY SEWER LINES AND DOMESTIC WATER AND FIRE PROTECTION SYSTEM AS SHOWN ON THESE PLANS. THE CONTRACTOR SHALL FURNISH ALL NECESSARY MATERIALS, EQUIPMENT, MACHINERY, TOOLS. MEANS OF TRANSPORTATION AND LABOR NECESSARY TO COMPLETE THE WORK IN FULL AND COMPLETE ACCORDANCE WITH THE SHOWN, DESCRIBED AND REASONABLY INTENDED REQUIREMENTS OF THE CONTRACT DOCUMENTS AND JURISDICTIONAL AGENCY REQUIREMENTS. IN THE EVENT THAT THE CONTRACT DOCUMENTS AND THE JURISDICTIONAL AGENCY REQUIREMENTS ARE NOT IN AGREEMENT, THE MOST STRINGENT SHALL GOVERN.
- ALL EXISTING UNDERGROUND UTILITY LOCATIONS SHOWN ARE APPROXIMATE THE CONTRACTOR SHALL COMPLY WITH ALL REQUIREMENTS FOR UTILITY LOCATION AND COORDINATION IN ACCORDANCE WITH THE NOTES CONTAINED IN THE GENERAL CONSTRUCTION SECTION OF THIS SHEET.
- 3. THE CONTRACTOR SHALL RESTORE ALL DISTURBED VEGETATION IN KIND, UNLESS SHOWN OTHERWISE.
- 4. DEFLECTION OF PIPE JOINTS AND CURVATURE OF PIPE SHALL NOT EXCEED THE MANUFACTURER'S SPECIFICATIONS. SECURELY CLOSE ALL OPEN ENDS OF PIPE AND FITTINGS WITH A WATERTIGHT PLUG WHEN WORK IS NOT IN PROGRESS. THE INTERIOR OF ALL PIPES SHALL BE CLEAN AND JOINT SURFACES WIPED CLEAN AND DRY AFTER THE PIPE HAS BEEN LOWERED INTO THE TRENCH. VALVES SHALL BE PLUMB AND LOCATED ACCORDING TO THE
- 5. ALL PHASES OF INSTALLATION, INCLUDING UNLOADING, TRENCHING, LAYING AND BACK FILLING, SHALL BE DONE IN A FIRST CLASS WORKMANLIKE MANNER. ALL PIPE AND FITTINGS SHALL BE CAREFULLY STORED FOLLOWING MANUFACTURER'S RECOMMENDATIONS. CARE SHALL BE TAKEN TO AVOID DAMAGE TO THE COATING OR LINING IN ANY D.I. PIPE FITTINGS. ANY PIPE OR FITTING WHICH IS DAMAGED OR WHICH HAS FLAWS OR IMPERFECTIONS WHICH, IN THE OPINION OF THE ENGINEER OR OWNER, RENDERS IT UNFIT FOR USE, SHALL NOT BE USED. ANY PIPE NOT SATISFACTORY FOR USE SHALL BE CLEARLY MARKED AND IMMEDIATELY REMOVED FROM THE JOB SITE, AND SHALL BE REPLACED AT THE CONTRACTOR'S EXPENSE.
- 6. WATER FOR FIRE FIGHTING SHALL BE AVAILABLE FOR USE PRIOR TO COMBUSTIBLES BEING BROUGHT ON SITE.
- 7. ALL UTILITY AND STORM DRAIN TRENCHES LOCATED UNDER AREAS TO RECEIVE PAVING SHALL BE COMPLETELY BACK FILLED IN ACCORDANCE WITH THE GOVERNING JURISDICTIONAL AGENCY'S SPECIFICATIONS. IN THE EVENT THAT THE CONTRACT DOCUMENTS AND THE JURISDICTIONAL AGENCY REQUIREMENTS ARE NOT IN AGREEMENT, THE MOST STRINGENT SHALL GOVERN.
- 8. UNDERGROUND LINES SHALL BE SURVEYED BY A STATE OF FLORIDA PROFESSIONAL LAND SURVEYOR PRIOR TO BACK FILLING.
- 9. CONTRACTOR SHALL PERFORM, AT HIS OWN EXPENSE, ANY AND ALL TESTS REQUIRED BY THE SPECIFICATIONS AND/OR ANY AGENCY HAVING JURISDICTION. THESE TESTS MAY INCLUDE. BUT MAY NOT BE LIMITED TO, INFILTRATION AND EXFILTRATION, TELEVISION INSPECTION AND A MANDREL TEST ON GRAVITY SEWER. A COPY OF THE TEST RESULTS SHALL BE PROVIDED TO THE UTILITY PROVIDER, OWNER AND JURISDICTIONAL AGENCY AS REQUIRED.

EROSION CONTROL NOTES

- THE STORM WATER POLLUTION PREVENTION PLAN ("SWPPP") IS COMPRISED OF THIS EROSION CONTROL PLAN, THE STANDARD DETAILS, THE PLAN NARRATIVE, ATTACHMENTS INCLUDED IN SPECIFICATIONS OF THE SWPPP, PLUS THE PERMIT AND ALL SUBSEQUENT REPORTS AND RELATED DOCUMENTS.
- 2. ALL CONTRACTORS AND SUBCONTRACTORS INVOLVED WITH STORM WATER POLLUTION PREVENTION SHALL OBTAIN A COPY OF THE STORM WATER POLLUTION PREVENTION PLAN AND THE STATE OF FLORIDA NATIONAL POLLUTANT DISCHARGE ELIMINATION SYSTEM GENERAL PERMIT (NPDES PERMIT) AND BECOME FAMILIAR WITH THEIR CONTENTS.
- 3. THE CONTRACTOR SHALL IMPLEMENT BEST MANAGEMENT PRACTICES AS REQUIRED BY THE SWPPP. ADDITIONAL BEST MANAGEMENT PRACTICES SHALL BE IMPLEMENTED AS DICTATED BY CONDITIONS AT NO ADDITIONAL COST TO THE OWNER THROUGHOUT ALL PHASES OF CONSTRUCTION.
- 4. BEST MANAGEMENT PRACTICES (BMP'S) AND CONTROLS SHALL CONFORM TO FEDERAL, STATE, OR LOCAL REQUIREMENTS OR MANUAL OF PRACTICE, AS APPLICABLE. THE CONTRACTOR SHALL IMPLEMENT ADDITIONAL CONTROLS AS DIRECTED BY THE PERMITTING AGENCY OR OWNER.
- 5. PERMITS FOR ANY CONSTRUCTION ACTIVITY IMPACTING STATE WATERS OR REGULATED WETLANDS MUST BE MAINTAINED ON SITE AT ALL TIMES.
- 6. THE CONTRACTOR SHALL MINIMIZE CLEARING TO THE MAXIMUM EXTENT PRACTICAL OR AS REQUIRED BY THE GENERAL PERMIT.
- 7. CONTRACTOR SHALL DENOTE ON PLAN THE TEMPORARY PARKING AND STORAGE AREA WHICH SHALL ALSO BE USED AS THE EQUIPMENT MAINTENANCE AND CLEANING AREA. EMPLOYEE PARKING AREA, AND AREA FOR LOCATING PORTABLE FACILITIES, OFFICE TRAILERS, AND TOILET
- ALL WASH WATER (CONCRETE TRUCKS, VEHICLE CLEANING, EQUIPMENT CLEANING, ETC.) SHALL BE DETAINED AND PROPERLY TREATED OR DISPOSED.
- 9. SUFFICIENT OIL AND GREASE ABSORBING MATERIALS AND FLOTATION BOOMS SHALL BE MAINTAINED ON SITE OR READILY AVAILABLE TO CONTAIN AND CLEAN-UP FUEL OR CHEMICAL SPILLS AND LEAKS.
- 10. THE CONTRACTOR SHALL BE RESPONSIBLE FOR DUST CONTROL ON SITE. THE USE OF MOTOR OILS AND OTHER PETROLEUM BASED OR TOXIC LIQUIDS FOR DUST SUPPRESSION OPERATIONS IS PROHIBITED.
- SEALED CONTAINERS. MATERIALS SHALL BE PREVENTED FROM LEAVING THE PREMISES THROUGH THE ACTION OF WIND OR STORM WATER DISCHARGE INTO DRAINAGE DITCHES OR WATERS OF THE STATE.
- 12. ALL STORM WATER POLLUTION PREVENTION MEASURES PRESENTED ON THE PLAN, SHALL BE INITIATED AS SOON AS PRACTICABLE.
- 13. STABILIZATION PRACTICES SHOULD BE INITIATED AS SOON AS PRACTICAL, BUT IN NO CASE MORE THAN 7 DAYS WHERE CONSTRUCTION HAS TEMPORARILY CEASED.
- 14. DISTURBED PORTIONS OF THE SITE WHERE CONSTRUCTION ACTIVITY HAS PERMANENTLY STOPPED SHALL BE PERMANENTLY SEEDED. THESE AREAS SHALL BE SEEDED NO LATER THAN 7 DAYS AFTER THE LAST CONSTRUCTION ACTIVITY OCCURRED IN THESE AREAS. REFER TO SECTION 981 OF THE STANDARD SPECIFICATIONS FOR SEEDING AND MAINTENANCE REQUIREMENTS.
- 15. IF THE ACTION OF VEHICLES TRAVELING OVER THE GRAVEL CONSTRUCTION ENTRANCES IS NOT SUFFICIENT TO REMOVE THE MAJORITY OF DIRT OR MUD, THEN THE TIRES MUST BE WASHED BEFORE THE VEHICLES ENTER A PUBLIC ROAD. IF WASHING IS USED, PROVISIONS MUST BE MADE TO INTERCEPT THE WASH WATER AND TRAP THE SEDIMENT BEFORE IT IS CARRIED OFF THE SITE.
- 16. ALL MATERIALS SPILLED, DROPPED, WASHED, OR TRACKED FROM VEHICLES ONTO ROADWAYS OR INTO STORM DRAINS MUST BE REMOVED AS SOON AS POSSIBLE.
- 17. THE CONTRACTOR SHALL BE RESPONSIBLE FOR REMOVING SEDIMENT IN THE DETENTION POND AND ANY SEDIMENT THAT MAY HAVE COLLECTED IN THE STORM SEWER DRAINAGE SYSTEMS IN CONJUNCTION WITH THE STABILIZATION OF THE SITE.
- 18. ON-SITE & OFF SITE SOIL STOCKPILE AND BORROW AREAS SHALL BE PROTECTED FROM EROSION AND SEDIMENTATION THROUGH IMPLEMENTATION OF BEST MANAGEMENT PRACTICES. STOCKPILE AND BORROW AREA LOCATIONS SHALL BE NOTED ON THE EROSION CONTROL PLAN AND PERMITTED IN ACCORDANCE WITH GENERAL PERMIT REQUIREMENTS.
- 19. SLOPES SHALL BE LEFT IN A ROUGHENED CONDITION DURING THE GRADING PHASE TO REDUCE RUNOFF VELOCITIES AND EROSION.
- 20. DUE TO GRADE CHANGES DURING THE DEVELOPMENT OF THE PROJECT, THE CONTRACTOR SHALL BE RESPONSIBLE FOR ADJUSTING THE EROSION CONTROL MEASURES (SILT FENCES, ETC.) TO PREVENT EROSION.
- 21. ALL CONSTRUCTION SHALL BE STABILIZED AT THE END OF EACH WORKING DAY, THIS INCLUDES BACK FILLING OF TRENCHES FOR UTILITY CONSTRUCTION AND PLACEMENT OF GRAVEL OR BITUMINOUS PAVING FOR ROAD CONSTRUCTION.

Restaurant:

Raising Cane's Restaurant #0734 1917 West Tennessee St Tallahassee, FL P4E-AV [B] M


Designer's Information:

6767 Perkins Road, Suite 200 Baton Rouge, Louisiana 70808 Telephone: 225 769-0546 www.csrsinc.com

7	Prototype Phase:	2021-1.0 P4E-AV
	Project Issue Date:	02-03-2022
-	CSRS Project Manager:	Jŀ

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GENERAL

Sheet Number:

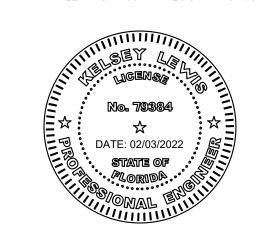PROJECT DATUM NAVD 88

SUNSHINE STATE ONE CALL OF FLORIDA, INC. 🗱

Know what's **below.**


Call before you dig.

CALL 2 WORKING DAYS


BEFORE YOU DIG

IT'S THE LAW!

DIAL 811

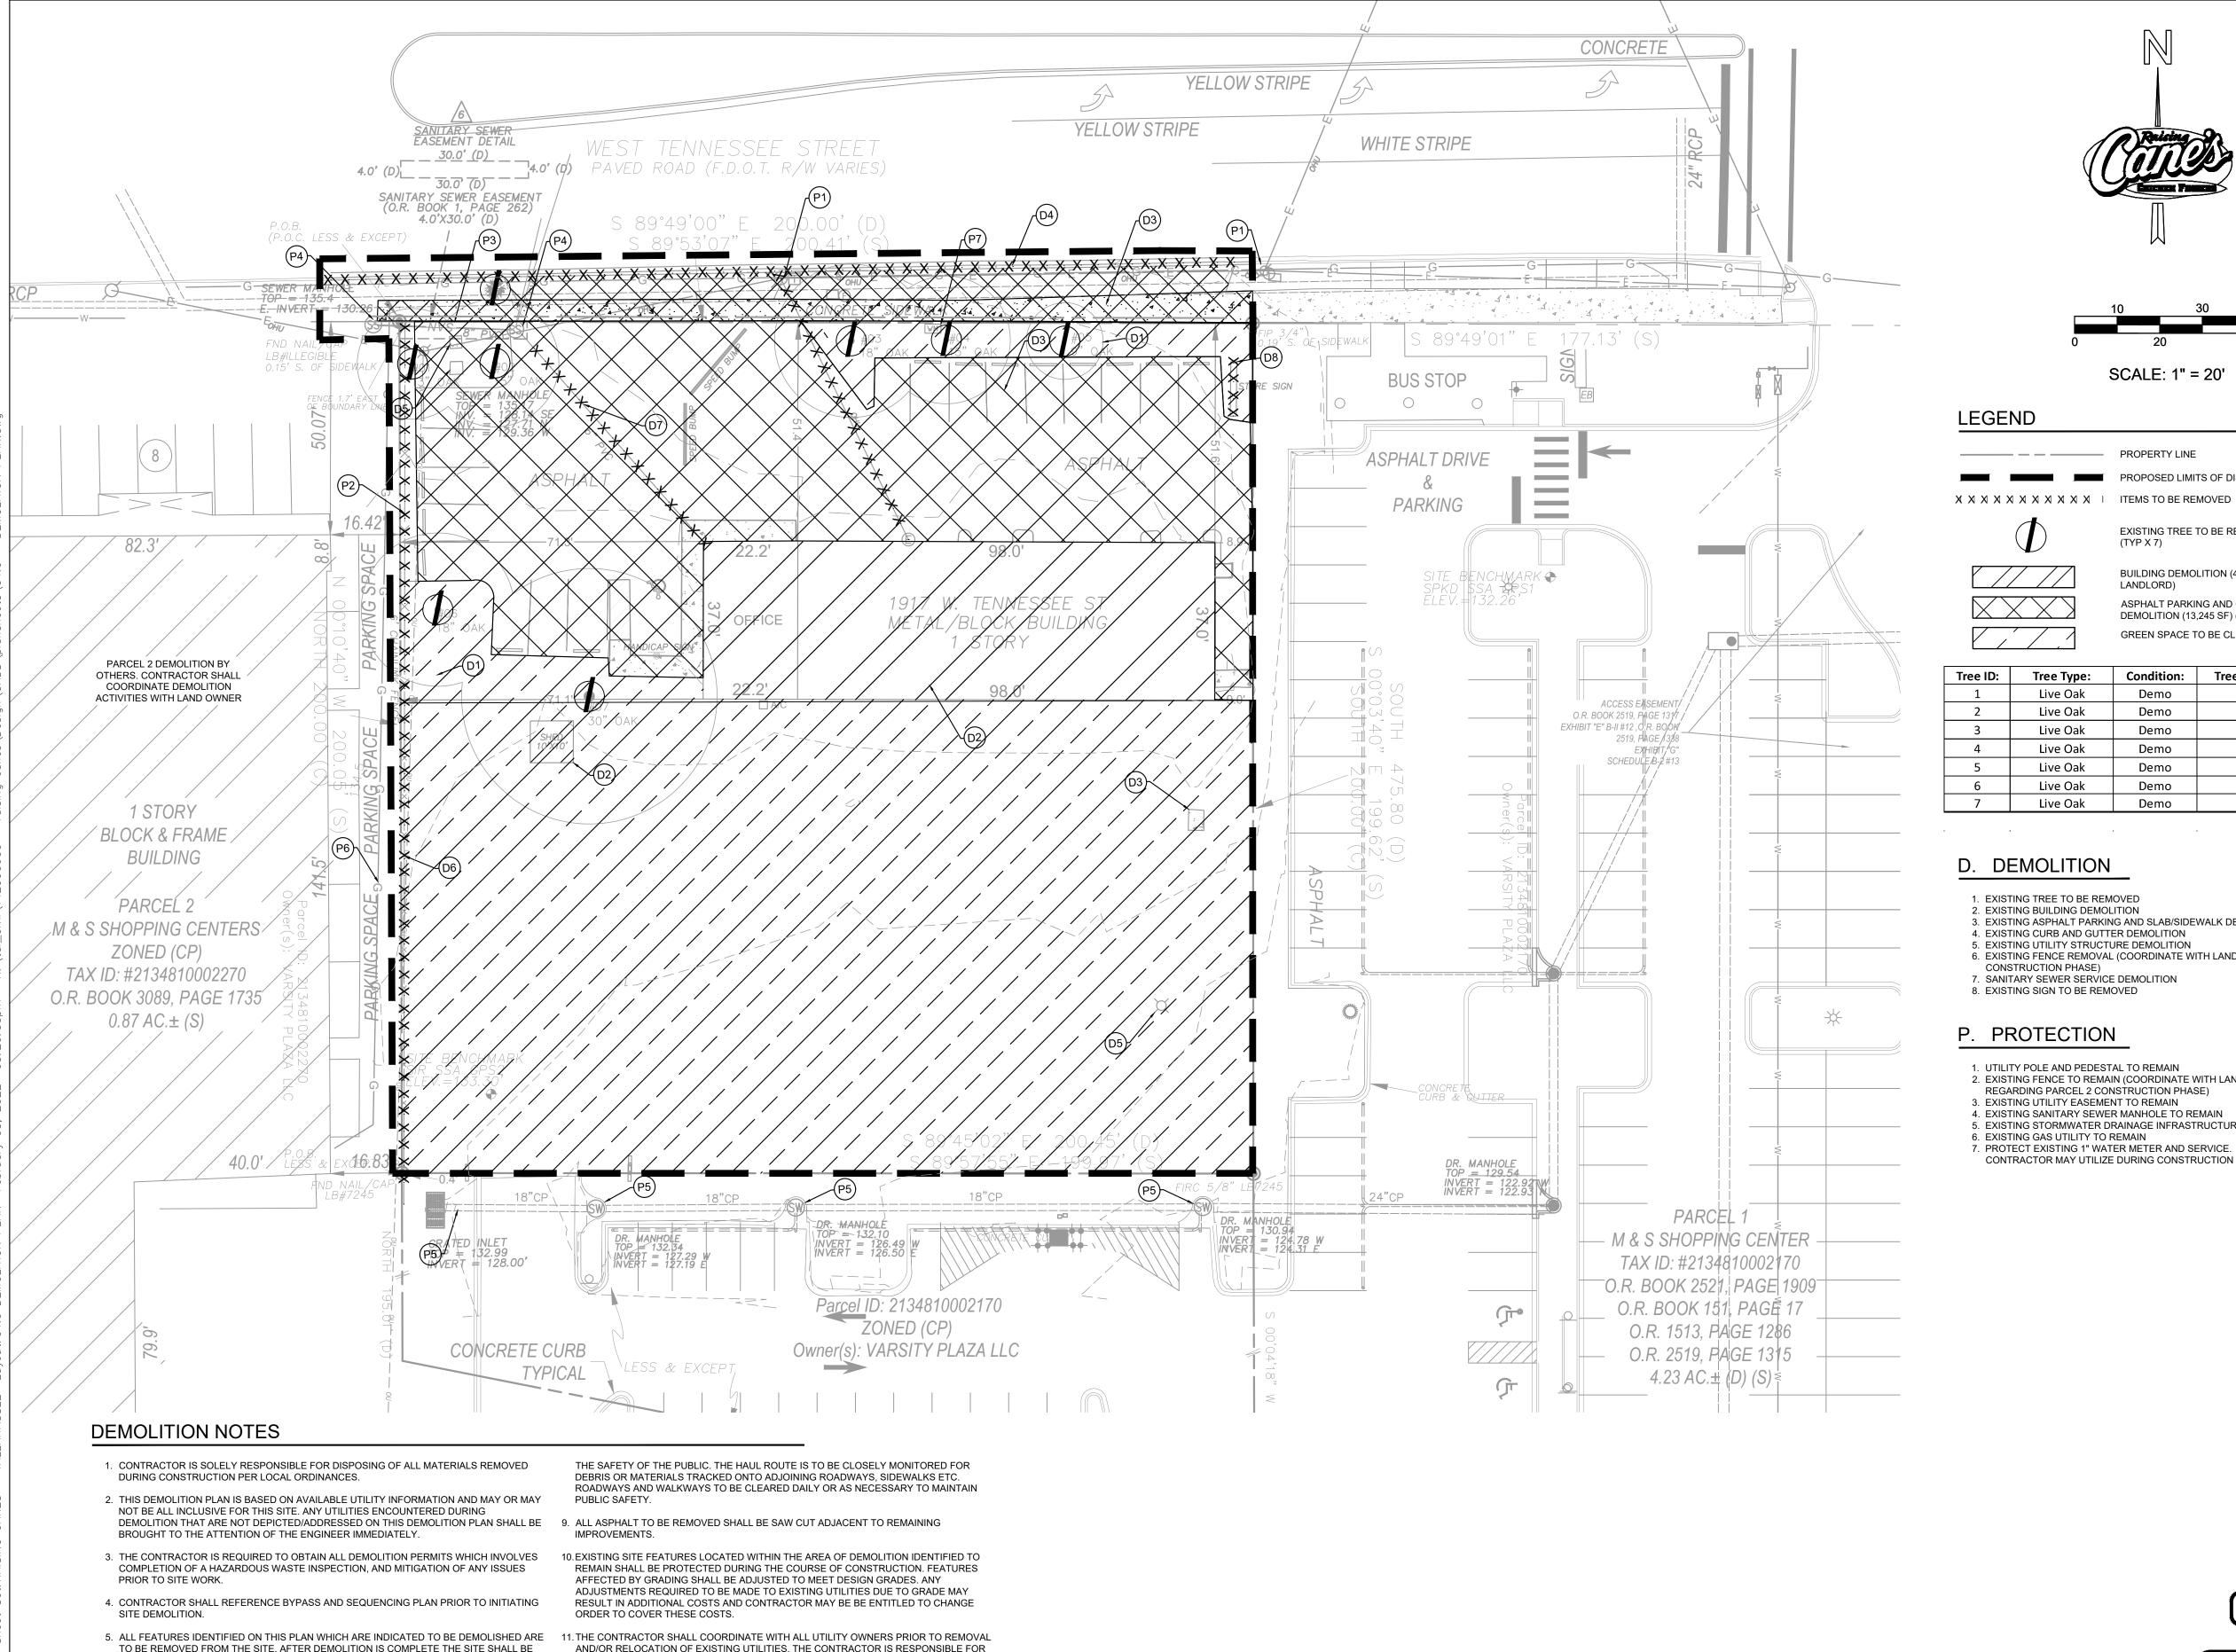



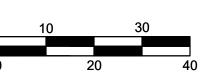

SCALE: 1" = 20'

PROPOSED LIMITS OF DISTURBANCE

EXISTING TREE TO BE REMOVED

BUILDING DEMOLITION (4,566 SF) (BY

ASPHALT PARKING AND CONCRETE SLAB/SIDEWALK DEMOLITION (13,245 SF) (BY LANDLORD)

GREEN SPACE TO BE CLEARED AND GRUBBED (24,305 SF)

Tree ID:	Tree Type:	Condition:	Tree Size (In):	Category:	Debits:
1	Live Oak	Demo	13	С	12
2	Live Oak	Demo	15	С	12
3	Live Oak	Demo	18	С	12
4	Live Oak	Demo	15	С	12
5	Live Oak	Demo	9	С	10
6	Live Oak	Demo	18	С	12
7	Live Oak	Demo	30	С	30
				Total	100

D. DEMOLITION

- 1. EXISTING TREE TO BE REMOVED 2. EXISTING BUILDING DEMOLITION
- 3. EXISTING ASPHALT PARKING AND SLAB/SIDEWALK DEMOLITION 4. EXISTING CURB AND GUTTER DEMOLITION
- 5. EXISTING UTILITY STRUCTURE DEMOLITION
- 6. EXISTING FENCE REMOVAL (COORDINATE WITH LAND OWNER REGARDING PARCEL 2 CONSTRUCTION PHASE)
- 7. SANITARY SEWER SERVICE DEMOLITION 8. EXISTING SIGN TO BE REMOVED

P. PROTECTION

1. UTILITY POLE AND PEDESTAL TO REMAIN 2. EXISTING FENCE TO REMAIN (COORDINATE WITH LAND OWNER

CONTRACTOR MAY UTILIZE DURING CONSTRUCTION ACTIVITIES

- REGARDING PARCEL 2 CONSTRUCTION PHASE)
- 3. EXISTING UTILITY EASEMENT TO REMAIN 4. EXISTING SANITARY SEWER MANHOLE TO REMAIN
- 5. EXISTING STORMWATER DRAINAGE INFRASTRUCTURE TO REMAIN 6. EXISTING GAS UTILITY TO REMAIN 7. PROTECT EXISTING 1" WATER METER AND SERVICE.

Restaurant:

Raising Cane's Restaurant #0734 1917 West Tennessee St. Tallahassee, FL P4E-AV [B] M

Designer's Information:


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Baton Rouge, Louisiana 70808 Telephone: 225 769-0546 www.csrsinc.com

P	rototype Phase:	2021-1.0 P4E-AV
P	roject Issue Date:	02-03-2022
C	SRS Project Manager:	Jŀ

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#	Date	Description

DEMOLITION PLAN

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PROJECT DATUM NAVD 88

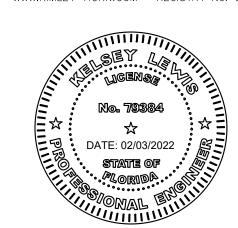CALL 2 WORKING DAYS BEFORE YOU DIG IT'S THE LAW! Know what's **below. DIAL 811**

SUNSHINE STATE ONE CALL OF FLORIDA, INC.

Call before you dig.

SURVEYOR AT THE EXPENSE OF THE CONTRACTOR.

- TO BE REMOVED FROM THE SITE. AFTER DEMOLITION IS COMPLETE THE SITE SHALL BE
- DELIVERED IN A CONDITION SUITABLE FOR DEVELOPMENT. 6. THE CONTRACTOR SHALL LIMIT ALL DEMOLITION ACTIVITIES TO THOSE AREAS DELINEATED ON THIS DEMOLITION PLAN UNLESS DIRECTED OTHERWISE BY THE
- 7. THE CONTRACTOR IS RESPONSIBLE FOR CONTROLLING AIRBORNE DUST AND POLLUTANTS BY USING WATER SPRINKLING OR OTHER SUITABLE MEANS OF CONTROL.


ENGINEER, OR AS REQUIRED FOR CONSTRUCTION OF IMPROVEMENTS.

8. THE CONTRACTOR SHALL USE CARE IN HANDLING DEBRIS FROM THE SITE TO ENSURE

AND/OR RELOCATION OF EXISTING UTILITIES. THE CONTRACTOR IS RESPONSIBLE FOR MAINTAINING AND PROTECTING UTILITIES WITHIN THE LIMITS OF CONSTRUCTION AND NOT INTERRUPTING UTILITY SERVICES TO ADJACENT PROPERTIES.

12.EXISTING SURVEY MONUMENTATION SHALL NOT BE DISTURBED; ANY DISTURBED OR REMOVED MONUMENTATION SHALL BE REPLACED BY A FLORIDA REGISTERED

13. CONTRACTOR TO MAINTAIN ACCESS TO ALL OCCUPIED BUSINESS AT ALL TIMES DURING CONSTRUCTION.

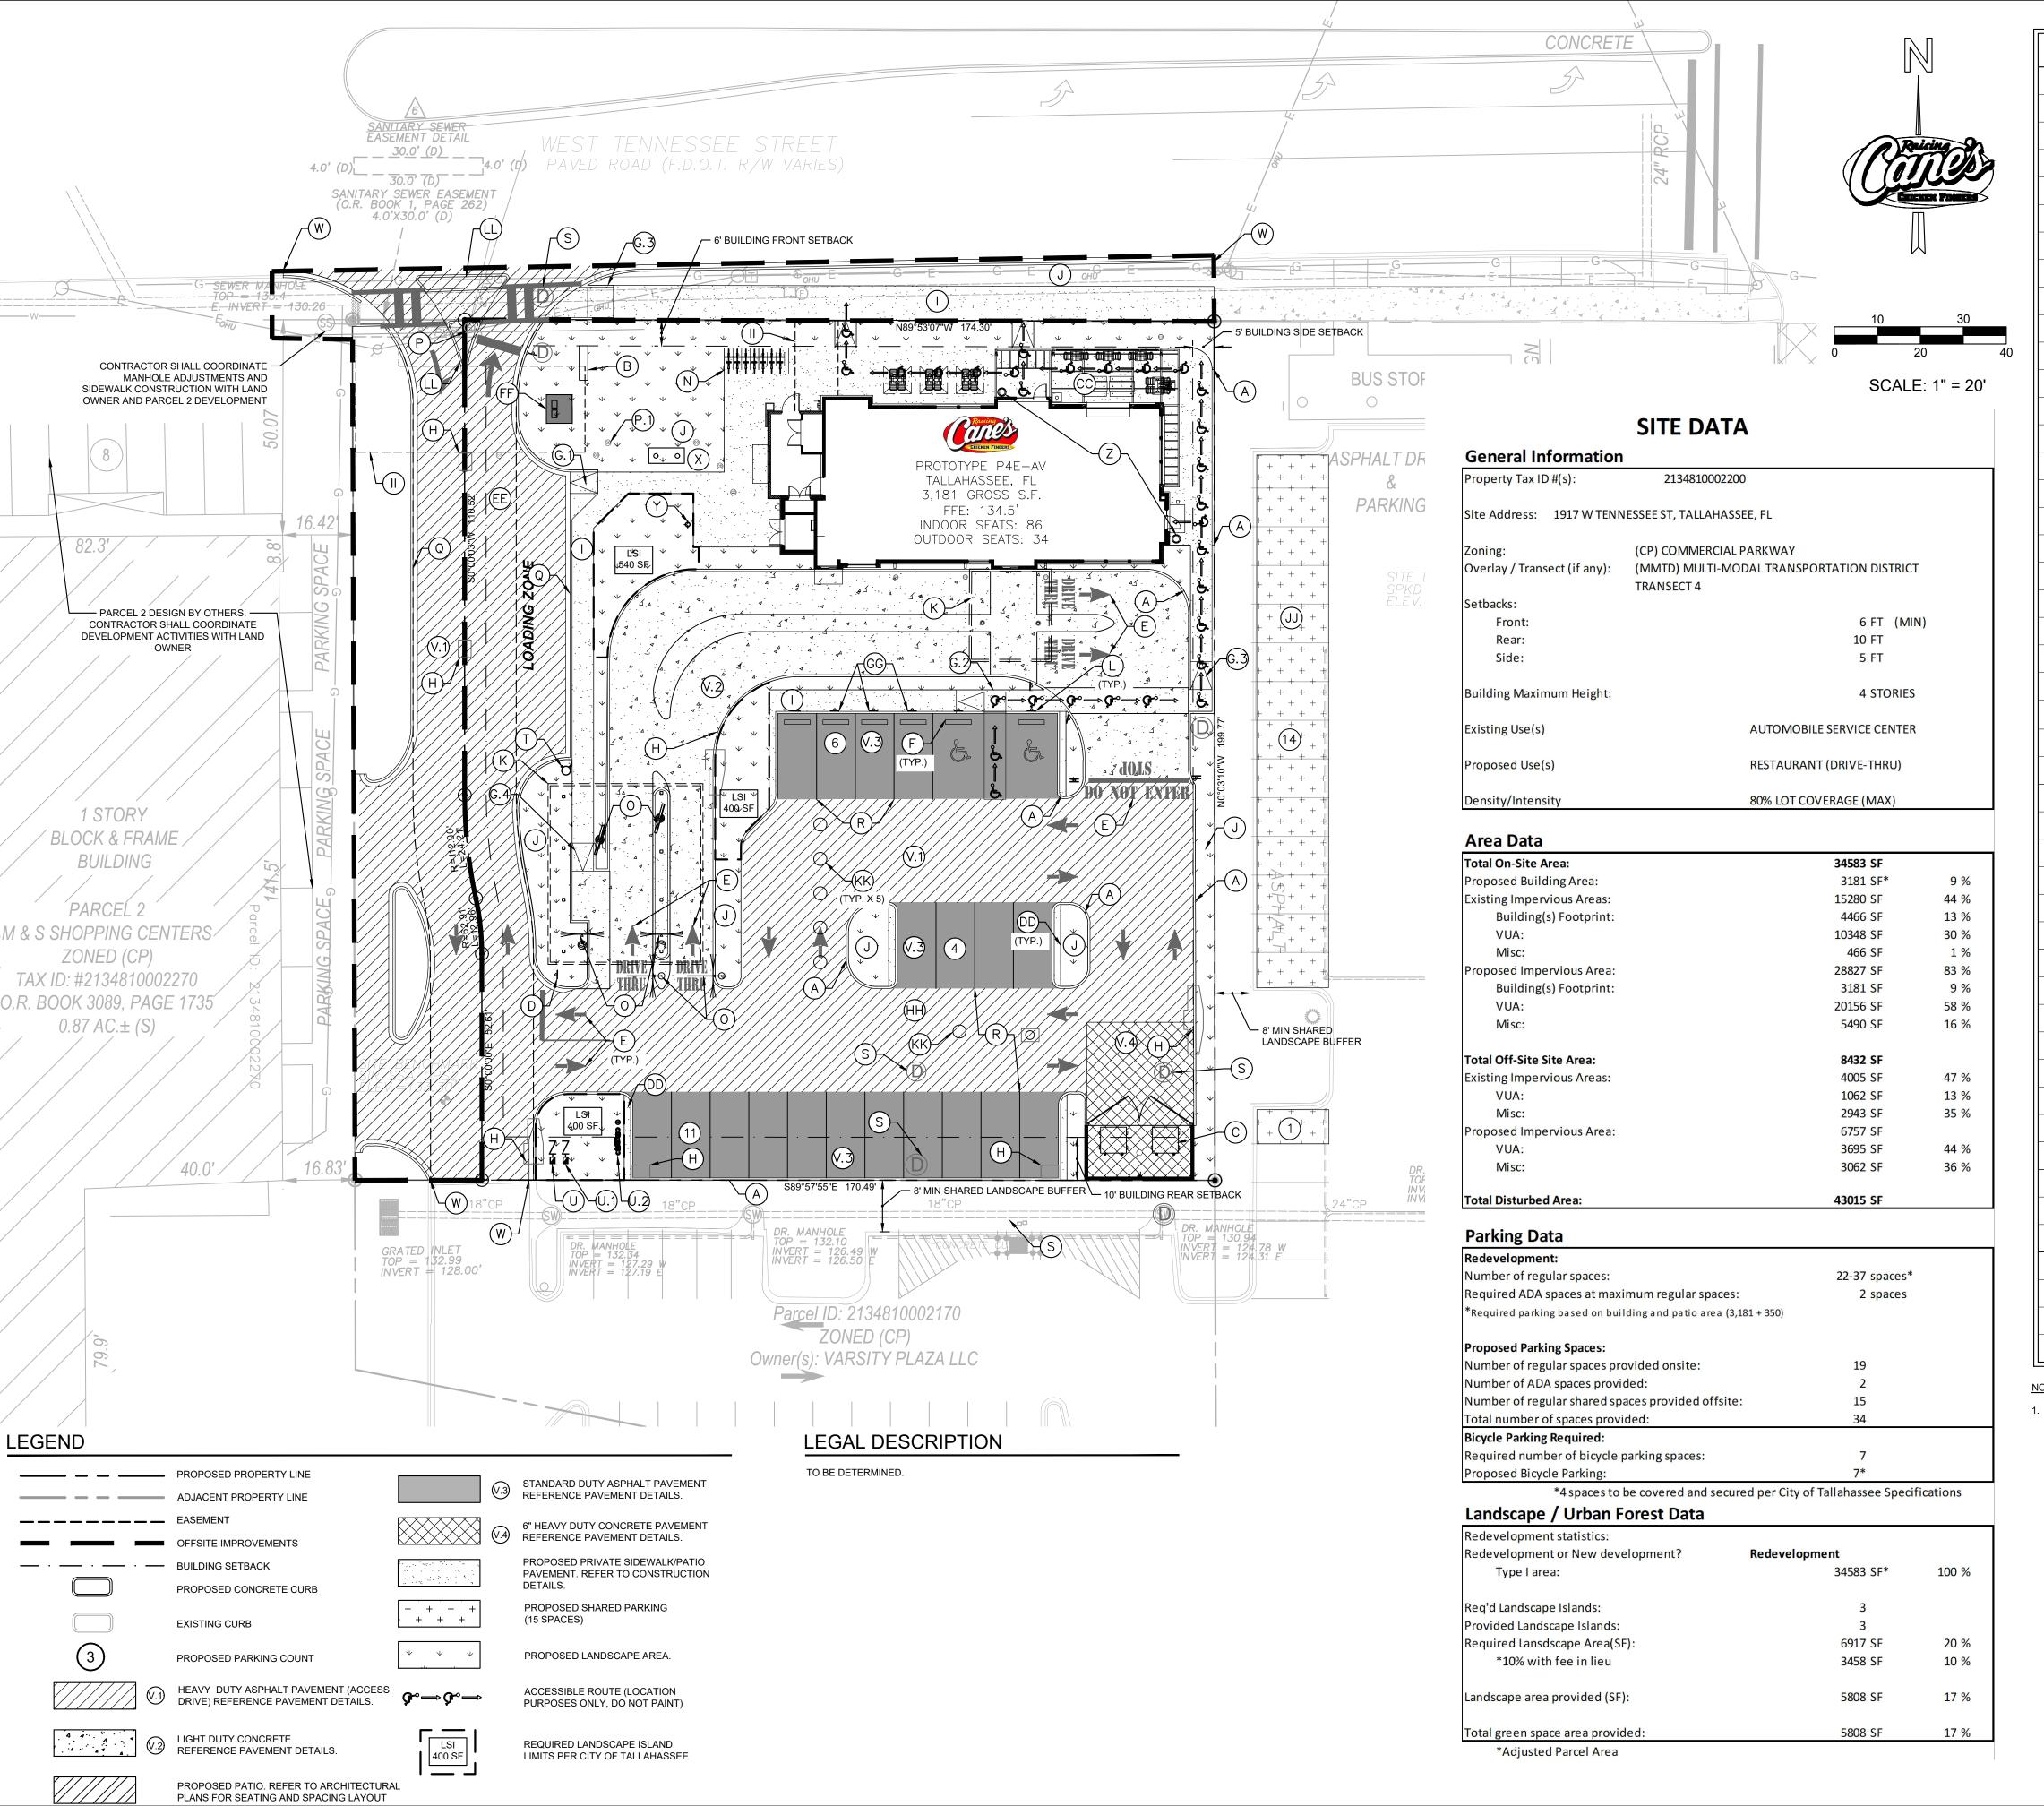

KEYNOTE LEGEND

- TYPE 'D' CURB. SHEET C8.0 CONSTRUCTION DETAILS PROPOSED RAISING CANES SIGN. REFER TO SIGNAGE PLAN FOR
- RECYCLING/TRASH DUMPSTER LOCATION. REFER TO ARCHITECTURAL PLANS FOR DETAILS OF SCREENING, GATES, BOLLARDS AND MASONRY
- DIRECTIONAL PAVEMENT MARKING. REFER TO SHEET C5.2 STRIPING AND SIGNAGE PLAN.

SITE DIRECTIONAL SIGN. REFE TO SHEET C5.2 - STRIPING AND

- WHEEL STOPS. REFER TO SHEET C8.0 CONSTRUCTION DETAILS
- FDOT MODIFIED TYPE 'CR-A' CURB RAMP. PER STD. INDEX 522-002.
- FDOT TYPE 'CR-C' CURB RAMP. PER STD. INDEX 522-002.
- FDOT TYPE 'CR-F' CURB RAMP. PER STD. INDEX 522-002.

FDOT TYPE 'CR-E' CURB RAMP. PER STD. INDEX 522-002.

CONCRETE SIDEWALK. REFER TO SHEET C8.0 - CONSTRUCTION

- PROPOSED STORM INLET.
- LANDSCAPE AREA. REFERENCE LANDSCAPE PLANS.
- PROPOSED DRIVE-THRU CANOPY. REFER TO ARCHITECTURAL PLANS FOR CANOPY DETAILS. ACCESSIBLE PARKING SIGN REFER TO SHEET C5.2 - STRIPING AND
- FUTURE DEVELOPMENT BY OTHERS
- BICYCLE RACK WITH ENCLOSURE. SEE ARCHITECTURAL PLANS
- DRIVE THRU ORDER BOARD, PRE-ORDER BOARD OR HEIGHT DETECTOR. REFER TO ARCHITECTURAL PLANS FOR DETAILS.
- EXISTING SANITARY SEWER MANHOLE
- PROPOSED SANITARY SEWER CLEANOUT
- MODIFIED TYPE 'F' CURB AND GUTTER. REFER TO SHEET C8.0 FOR
- CONSTRUCTION DETAILS PAVEMENT STRIPING. REFER TO SHEET C5.2 - STRIPING AND SIGNAGE
- PROPOSED STORM SEWER MANHOLE
- PROPOSED FIRE HYDRANT PER CITY OF TALLAHASSEE REQUIREMENTS.
- PROPOSED WATER METER. REFER TO SHEET C7.0 UTILITY PLAN.
- PROPOSED IRRIGATION BACKFLOW PREVENTER. REFER TO SHEET
- PROPOSED FIRE SERVICE BACKFLOW PREVENTER. REFER TO SHEET C7.0 - UTILITY PLAN. HEAVY DUTY ASPHALT PVMT. REFER TO SHEET C8.0 - CONSTRUCTION
- DETAILS. LIGHT DUTY CONCRETE. REFER TO SHEET C8.0 - CONSTRUCTION
- STANDARD DUTY ASPHALT PAVEMENT. REFER TO SHEET C8.0 -
- CONSTRUCTION DETAILS. 6" HEAVY DUTY CONCRETE PVMT. REFER TO SHEET C8.0 -
- CONSTRUCTION DETAILS. TIE PROPOSED CURB & GUTTER TO EXISTING CURB & GUTTER WITH
- SMOOTH, CONTINUOUS TRANSITION.
- (X) GREASE TRAP. REFER TO ARCHITECTURAL/MEP PLANS FOR DETAILS.
- REMOTE FDC. REFER TO SHEET C7.0 UTILITY PLAN
- BUSINESS NAME TILES. REFER TO ARCHITECTURAL PLANS FOR

TRASH PAD. REFER TO ARCHITECTURAL SITE DETAILS.

- CREW AMENITY STATION. REFER TO ARCHITECTURAL PLANS FOR
- PROPOSED PATIO AND CANOPY. REFER TO ARCHITECTURAL PLANS FOR SEATING AND SPACING LAYOUT AND CANOPY DETAILS.
- INSTALL 6" THICK CONCRETE BEHIND CURB. REFER TO SHEET C8.0 -CONSTRUCTION DETAILS.
- PROPOSED SHARED DRIVE AND CROSS ACCESS EASEMENT
- CITY OF TALLAHASSEE ELECTRIC TRANSFORMER PAD
- MOBILE ORDER PARKING SIGN. REFER TO SHEET C5.2 STRIPING AND SIGNAGE PLAN.
- CONTECH UNDERGROUND STORMWATER VAULT EXTENTS
- PROPOSED CITY OF TALLAHASSEE UTILITY EASEMENT
- REQUIRED SHARED PARKING
- UNDERGROUND STORM SYSTEM ACCESS COVER
- FDOT TYPE 1 (OPT 2) TRAFFIC SEPARATOR PER STD. INDEX 520-020

1. DUMPSTER ENCLOSURE SHALL HAVE A 12 FT CLEAR OPENING. GATE POLES SHALL NOT BE LOCATED WITHIN REQUIRED DIMENSIONS OF PAD.

PROJECT DATUM NAVD 88



Restaurant:

Raising Cane's Restaurant #0734 1917 West Tennessee St. Tallahassee, FL P4E-AV [B] M

Designer's Information:

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Prototype Phase:	2021-1.0 P4E-A
Project Issue Date:	03-04-202
CSRS Project Manager:	JI

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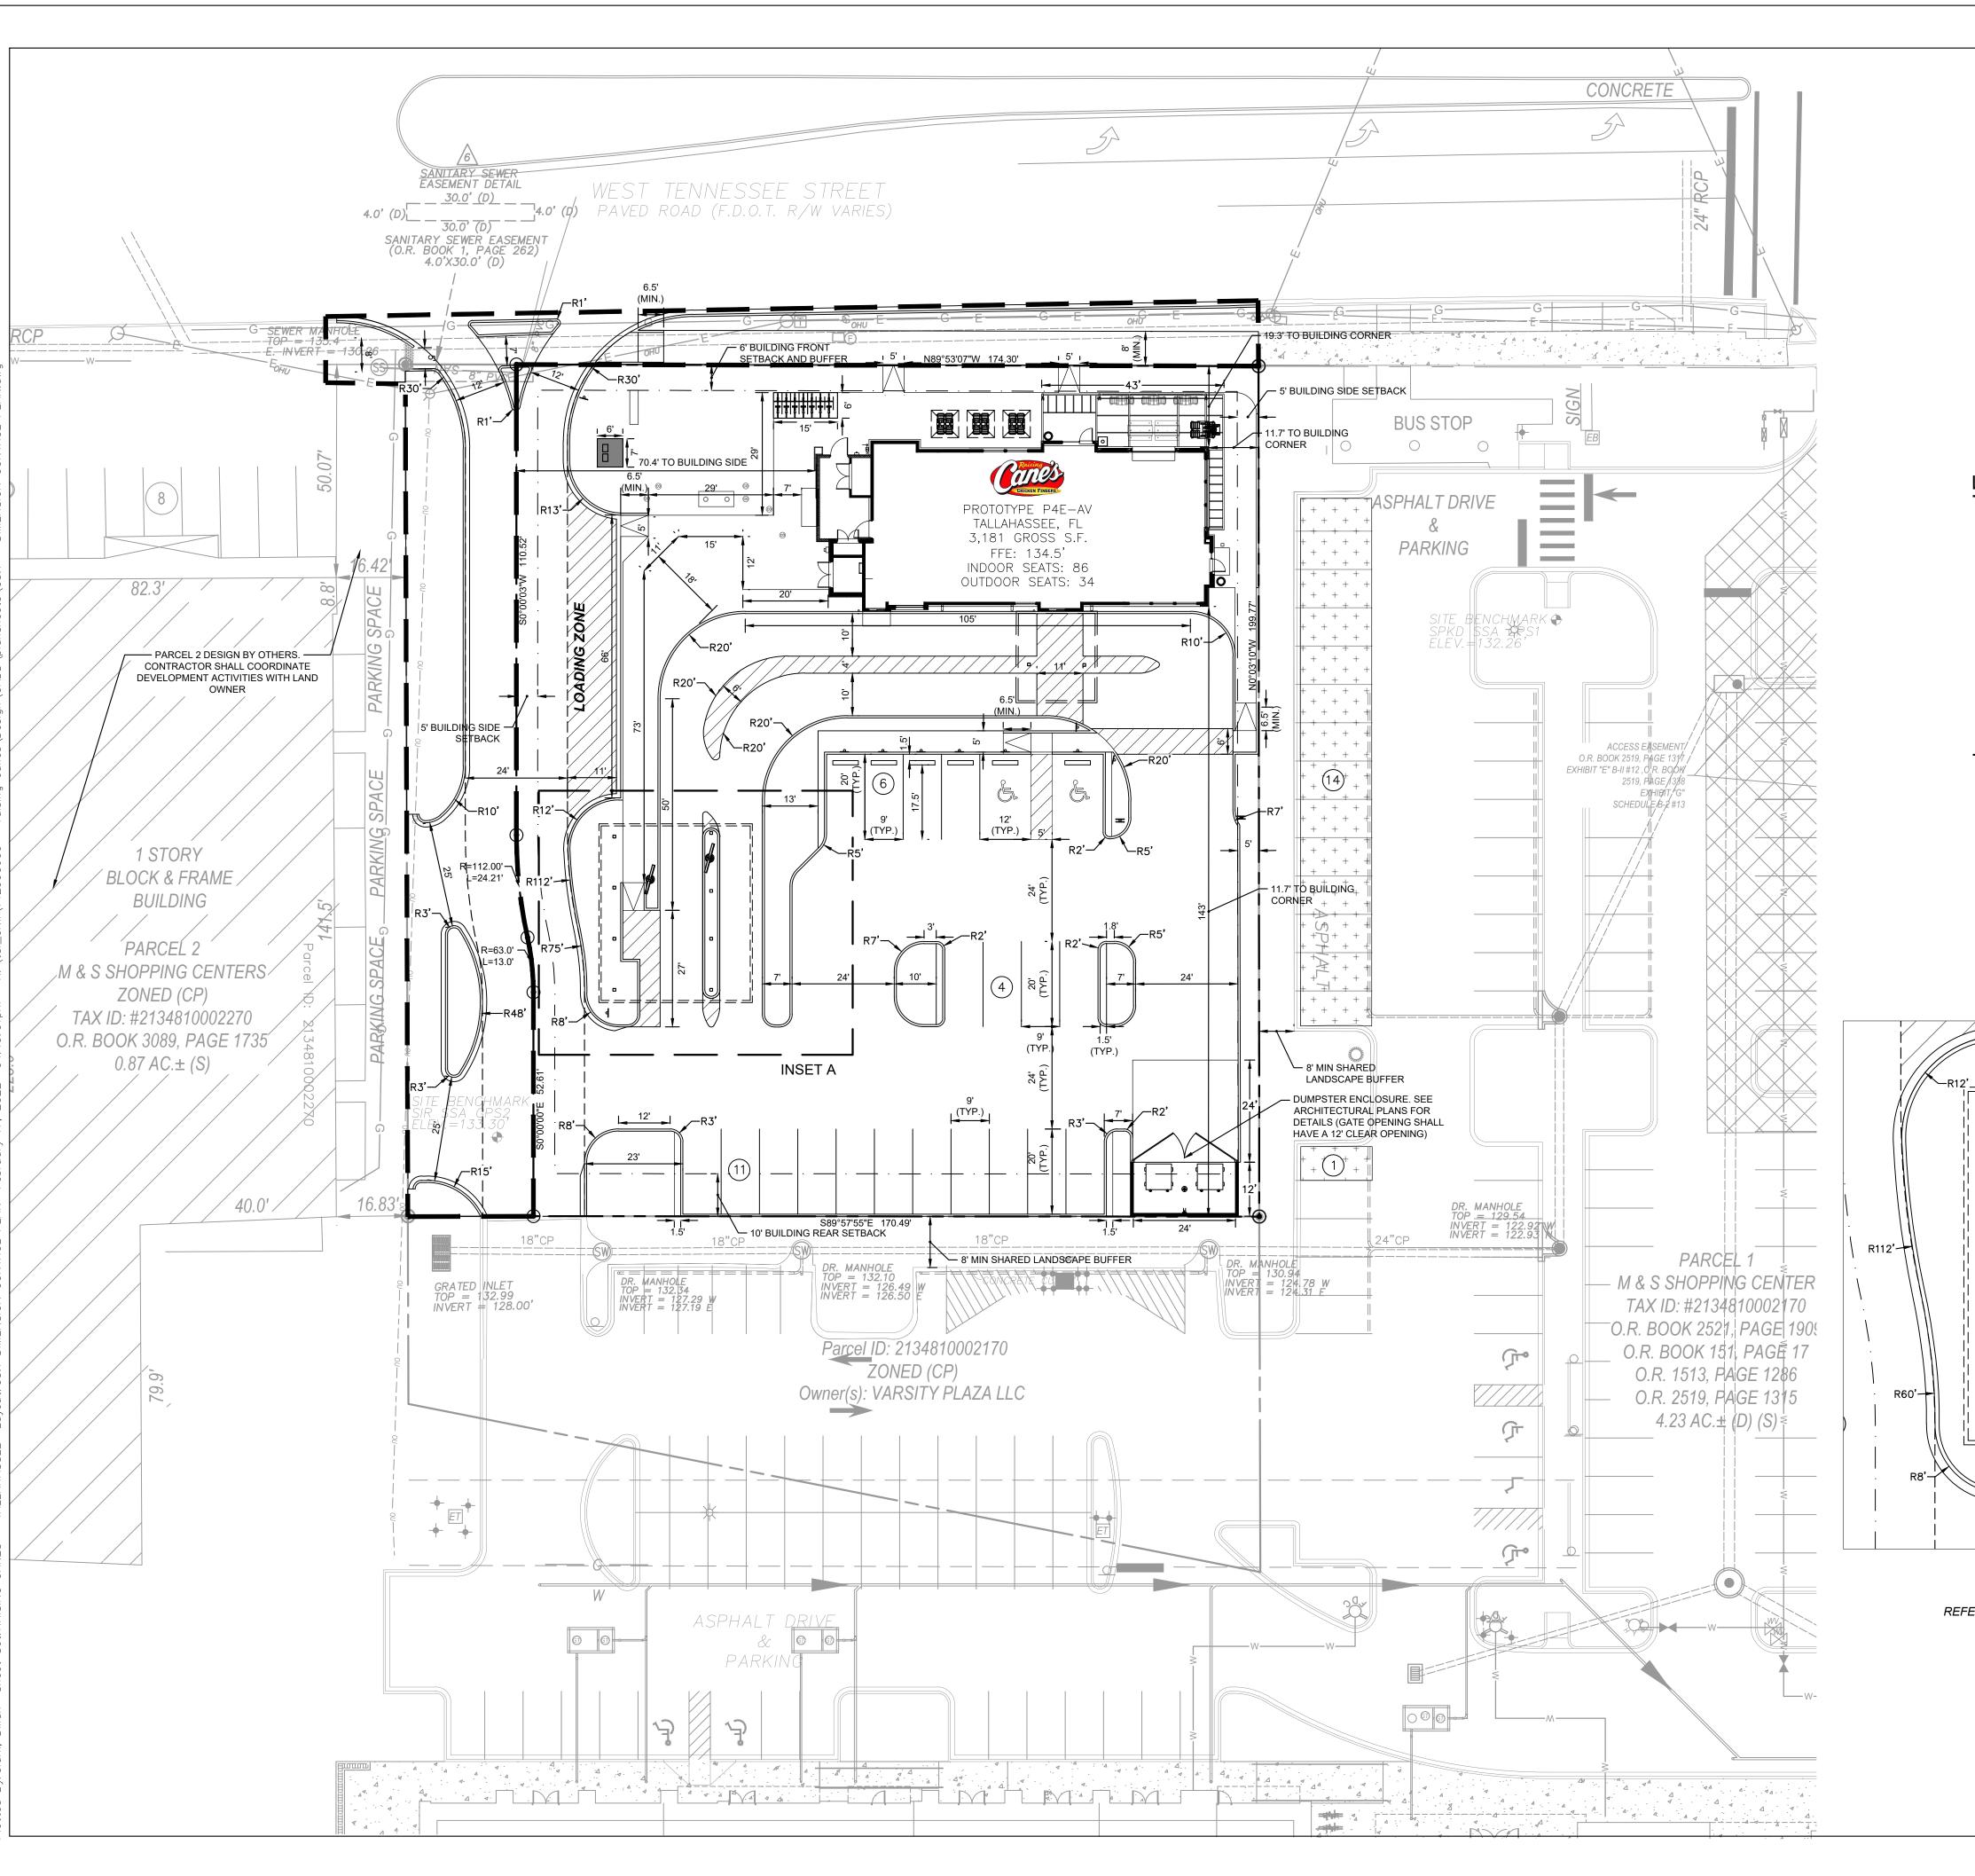
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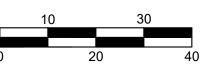
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SITE KEYNOTE **PLAN**

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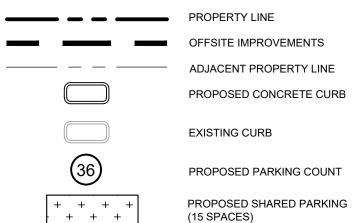







SCALE: 1" = 20'

LEGEND



DIMENSION NOTES

- ALL DIMENSIONS ARE TO FACE OF CURB UNLESS OTHERWISE NOTED.
- ALL CURBS SHALL BE 6" STANDARD EXCEPT WHERE OTHERWISE NOTED ON PLANS.
- 3. REFERENCE LANDSCAPE PLANS FOR PROPOSED BUFFERS, SCREENING, AND PLANTING.
- 4. CITY OF TALLAHASSEE TRANSFORMER PAD SHALL BE LOCATED 12' MAX. FROM EDGE OF PAVEMENT TO CENTER

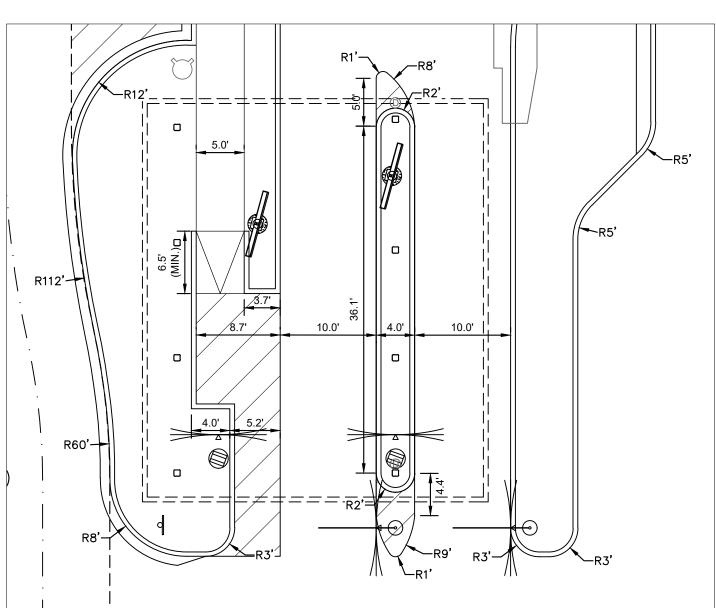

INSET A

SCALE:1"=10'

REFERENCE ARCHITECTURAL PLANS FOR DETAILS AND EXACT LOCATION OF MENU BOARD, HEIGHT DETECTOR AND PRE-ORDER BOARD.

PROJECT DATUM NAVD 88





Restaurant:

Raising Cane's
Restaurant #0734
1917 West Tennessee St.
Tallahassee, FL
P4E-AV [B] M

Designer's Information:

CSRS


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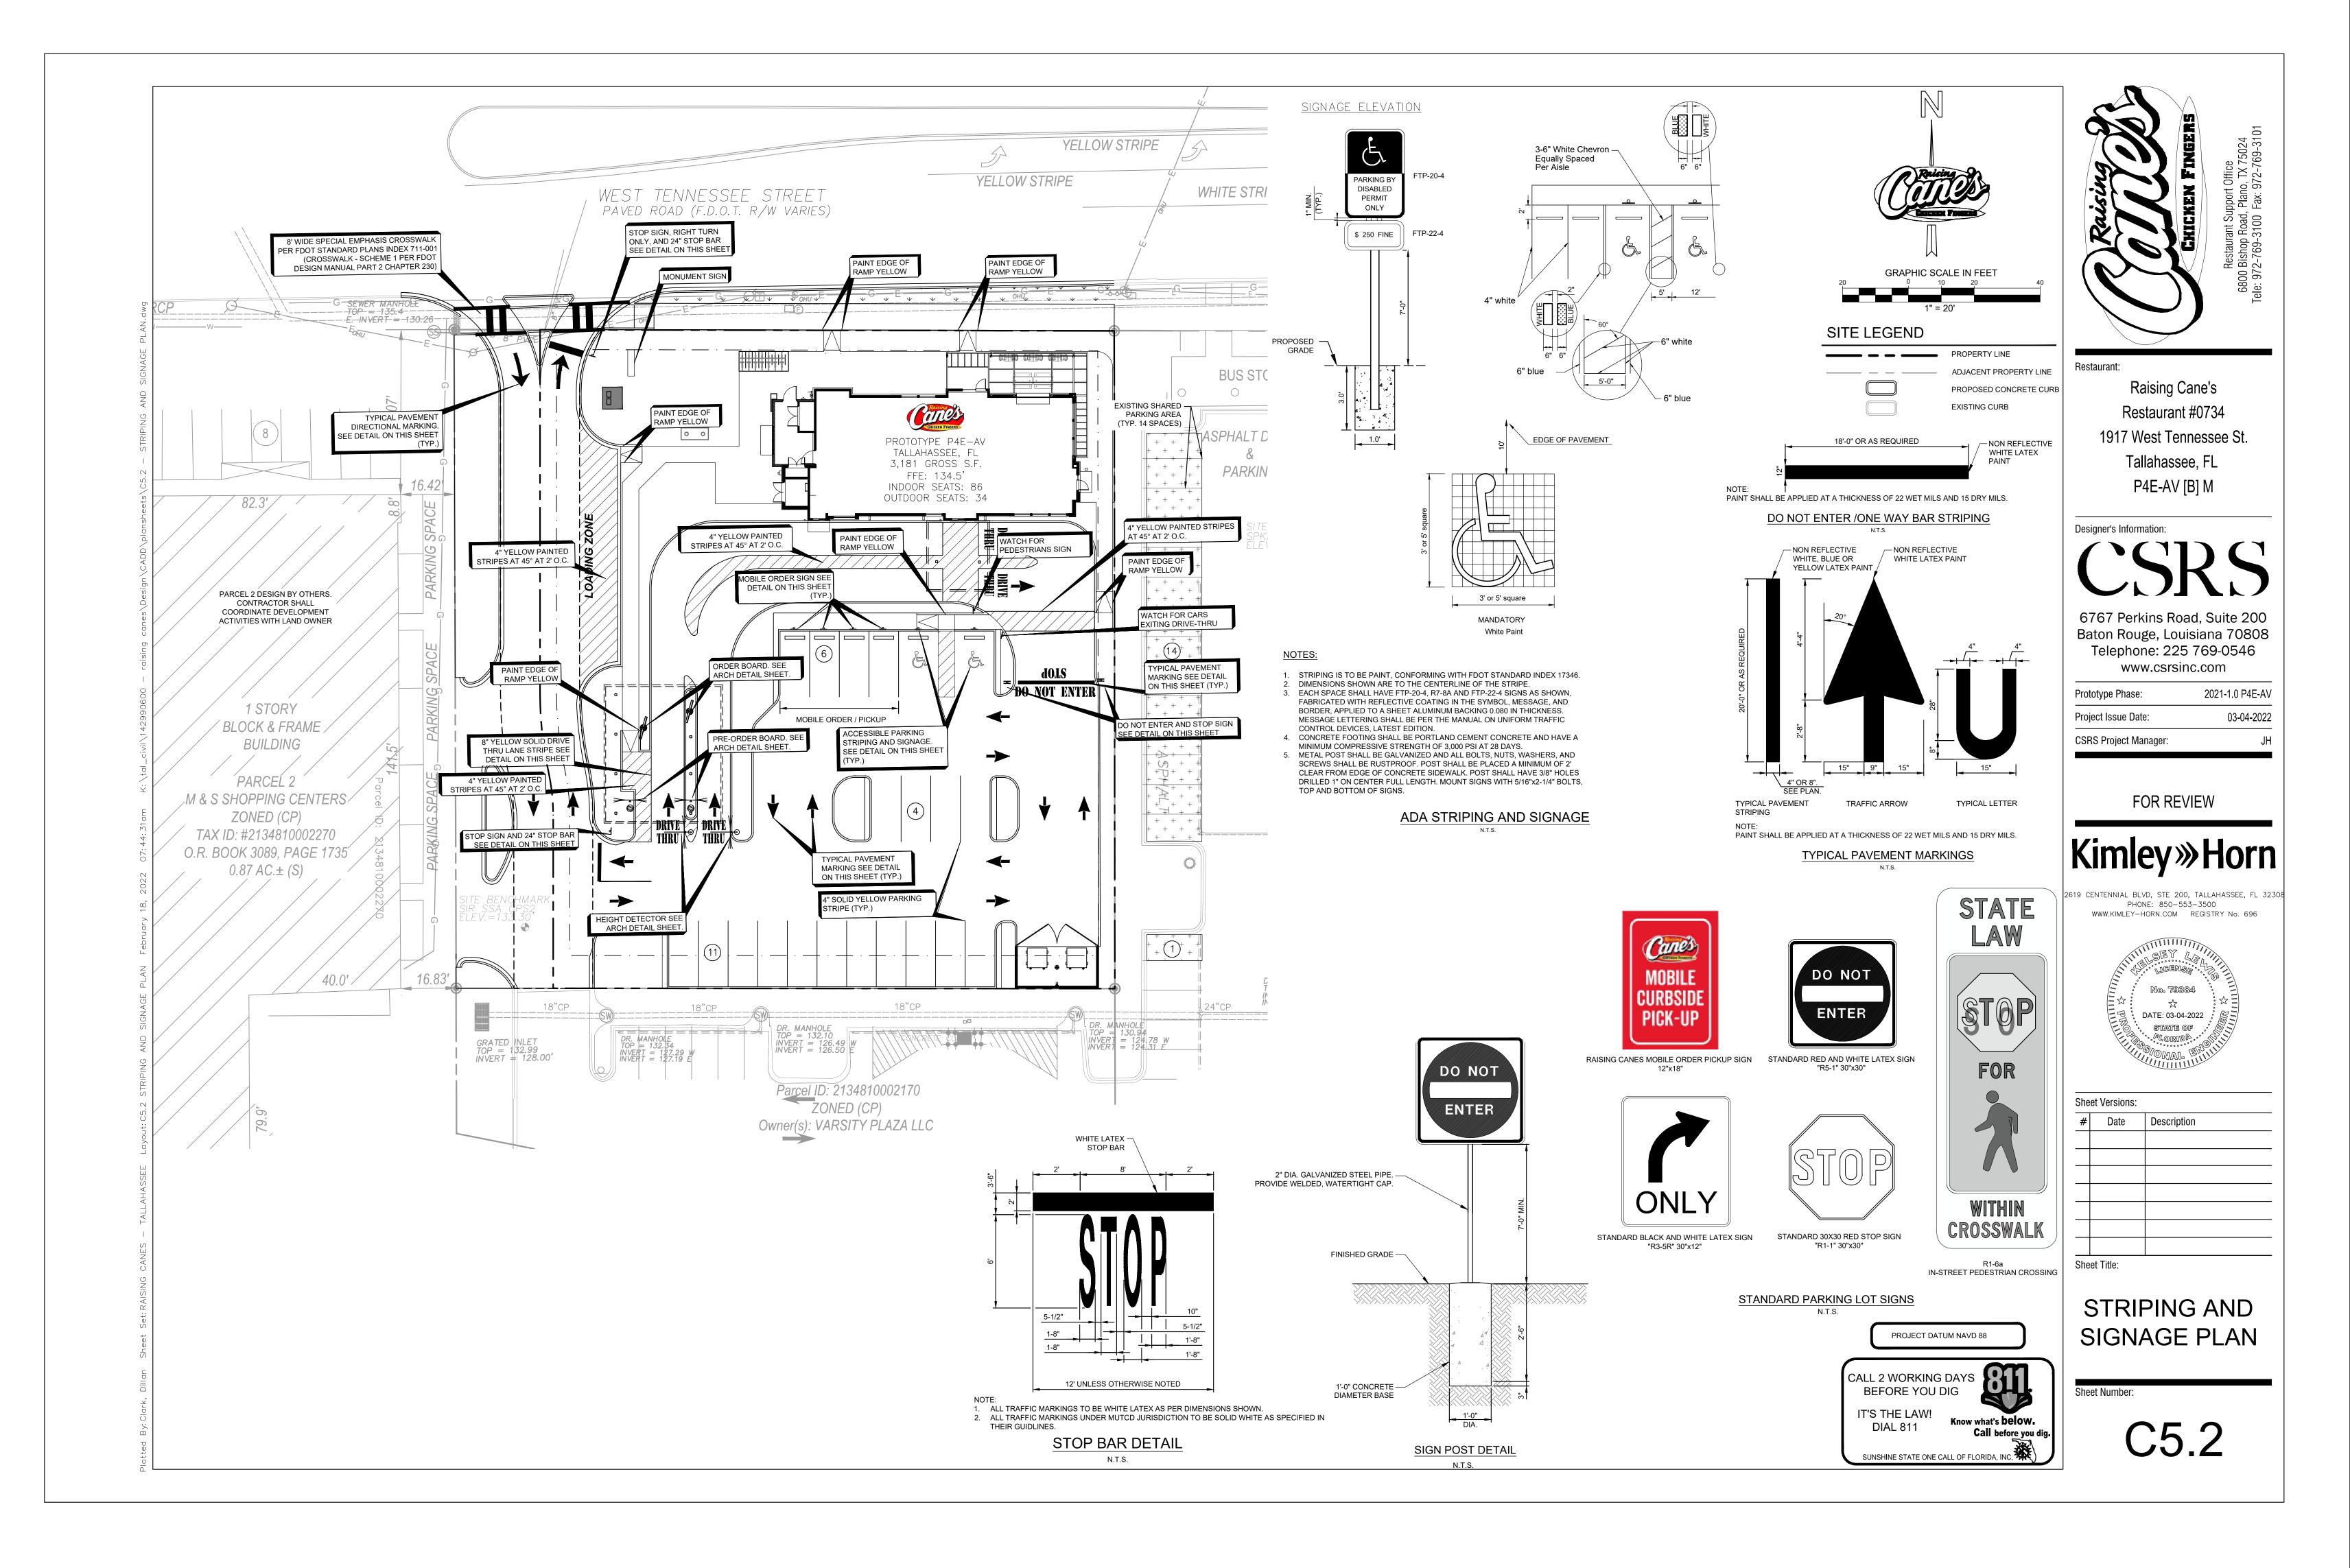



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DIMENSION CONTROL PLAN

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C5.1





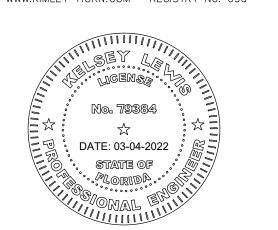
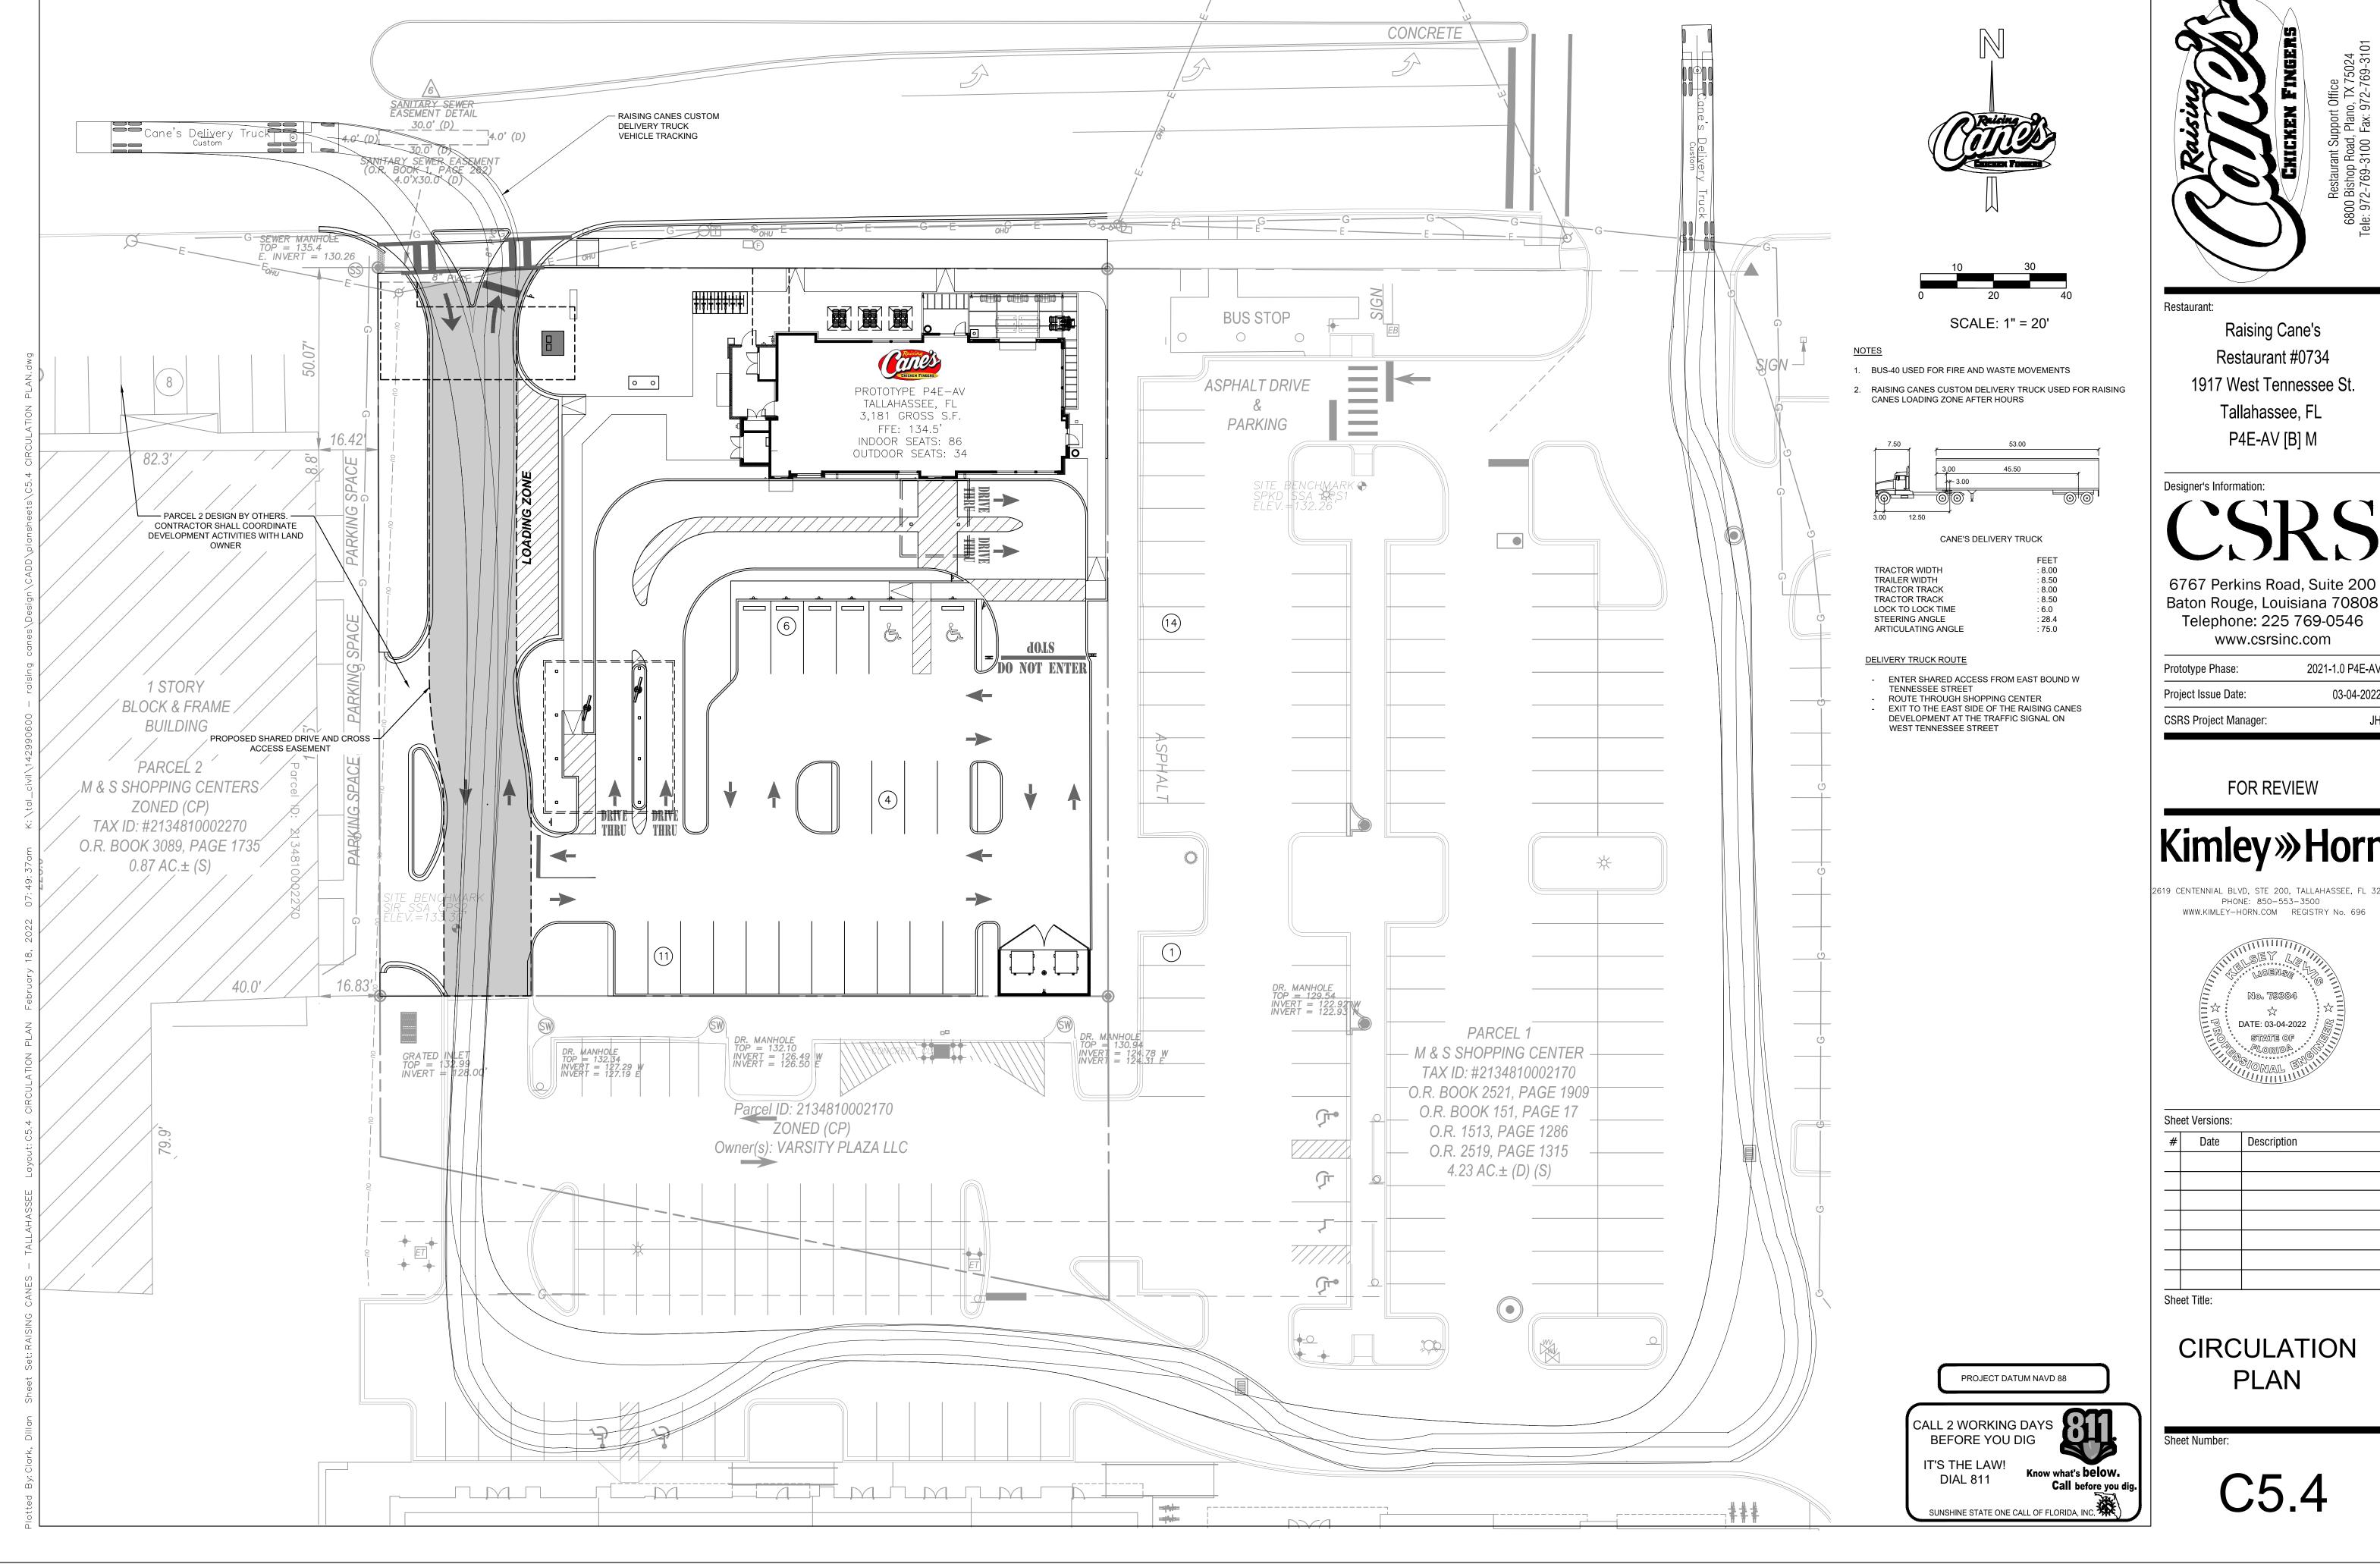
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2021-1.0 P4E-AV 03-04-2022


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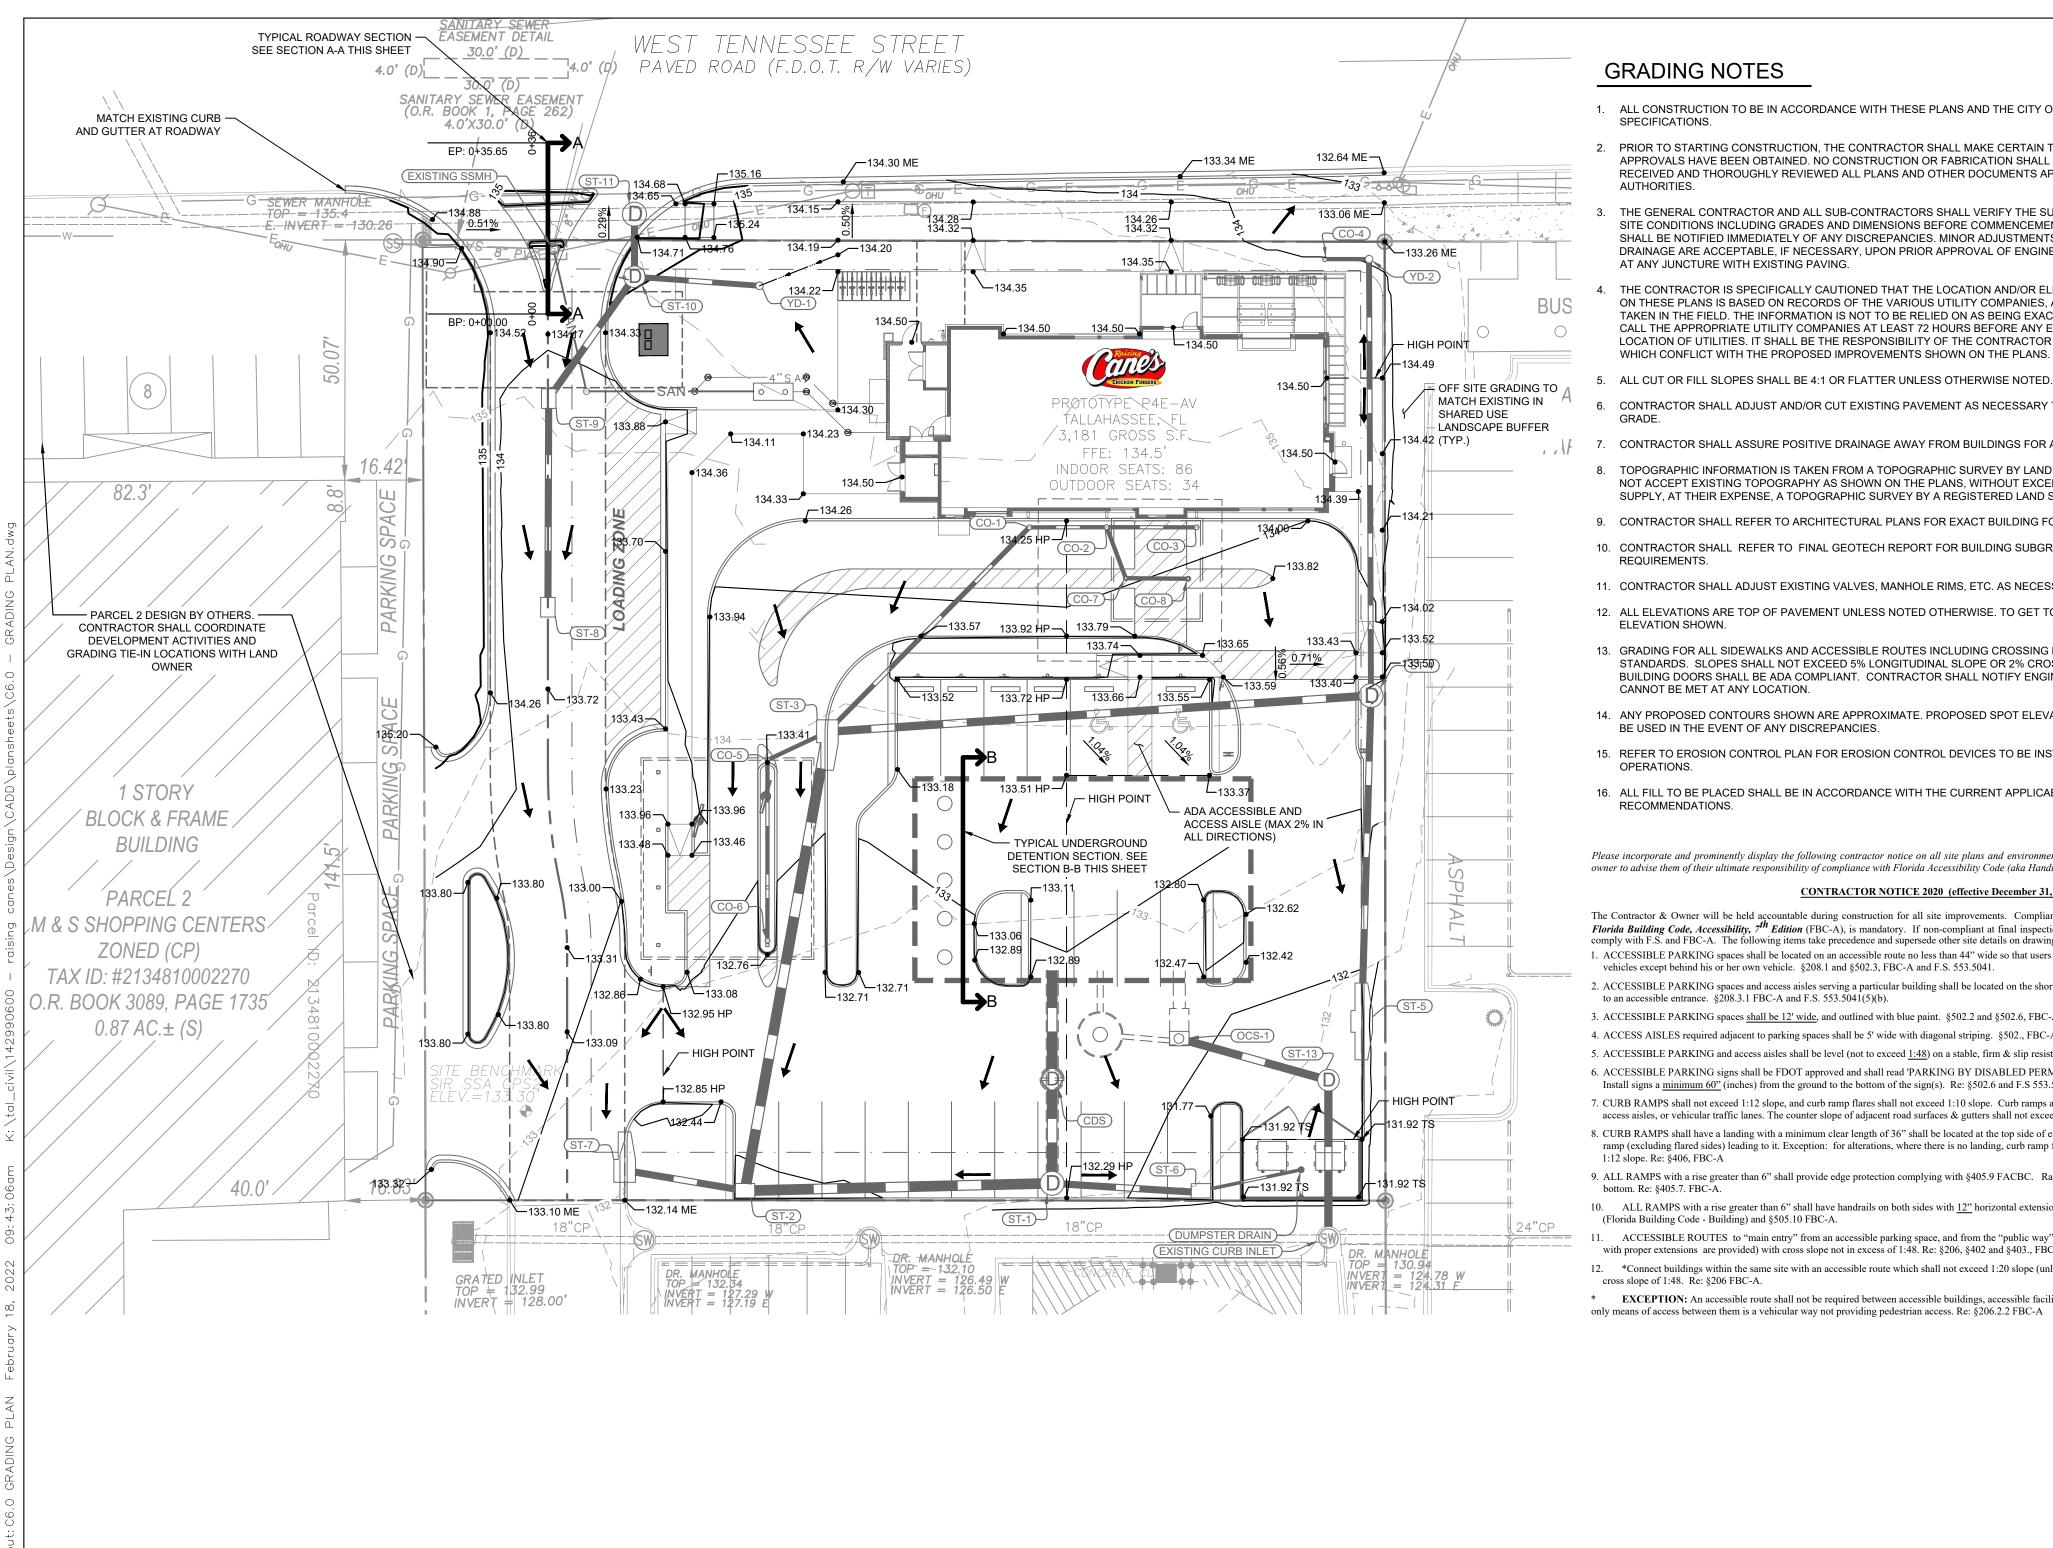


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CIRCULATION

C5.4



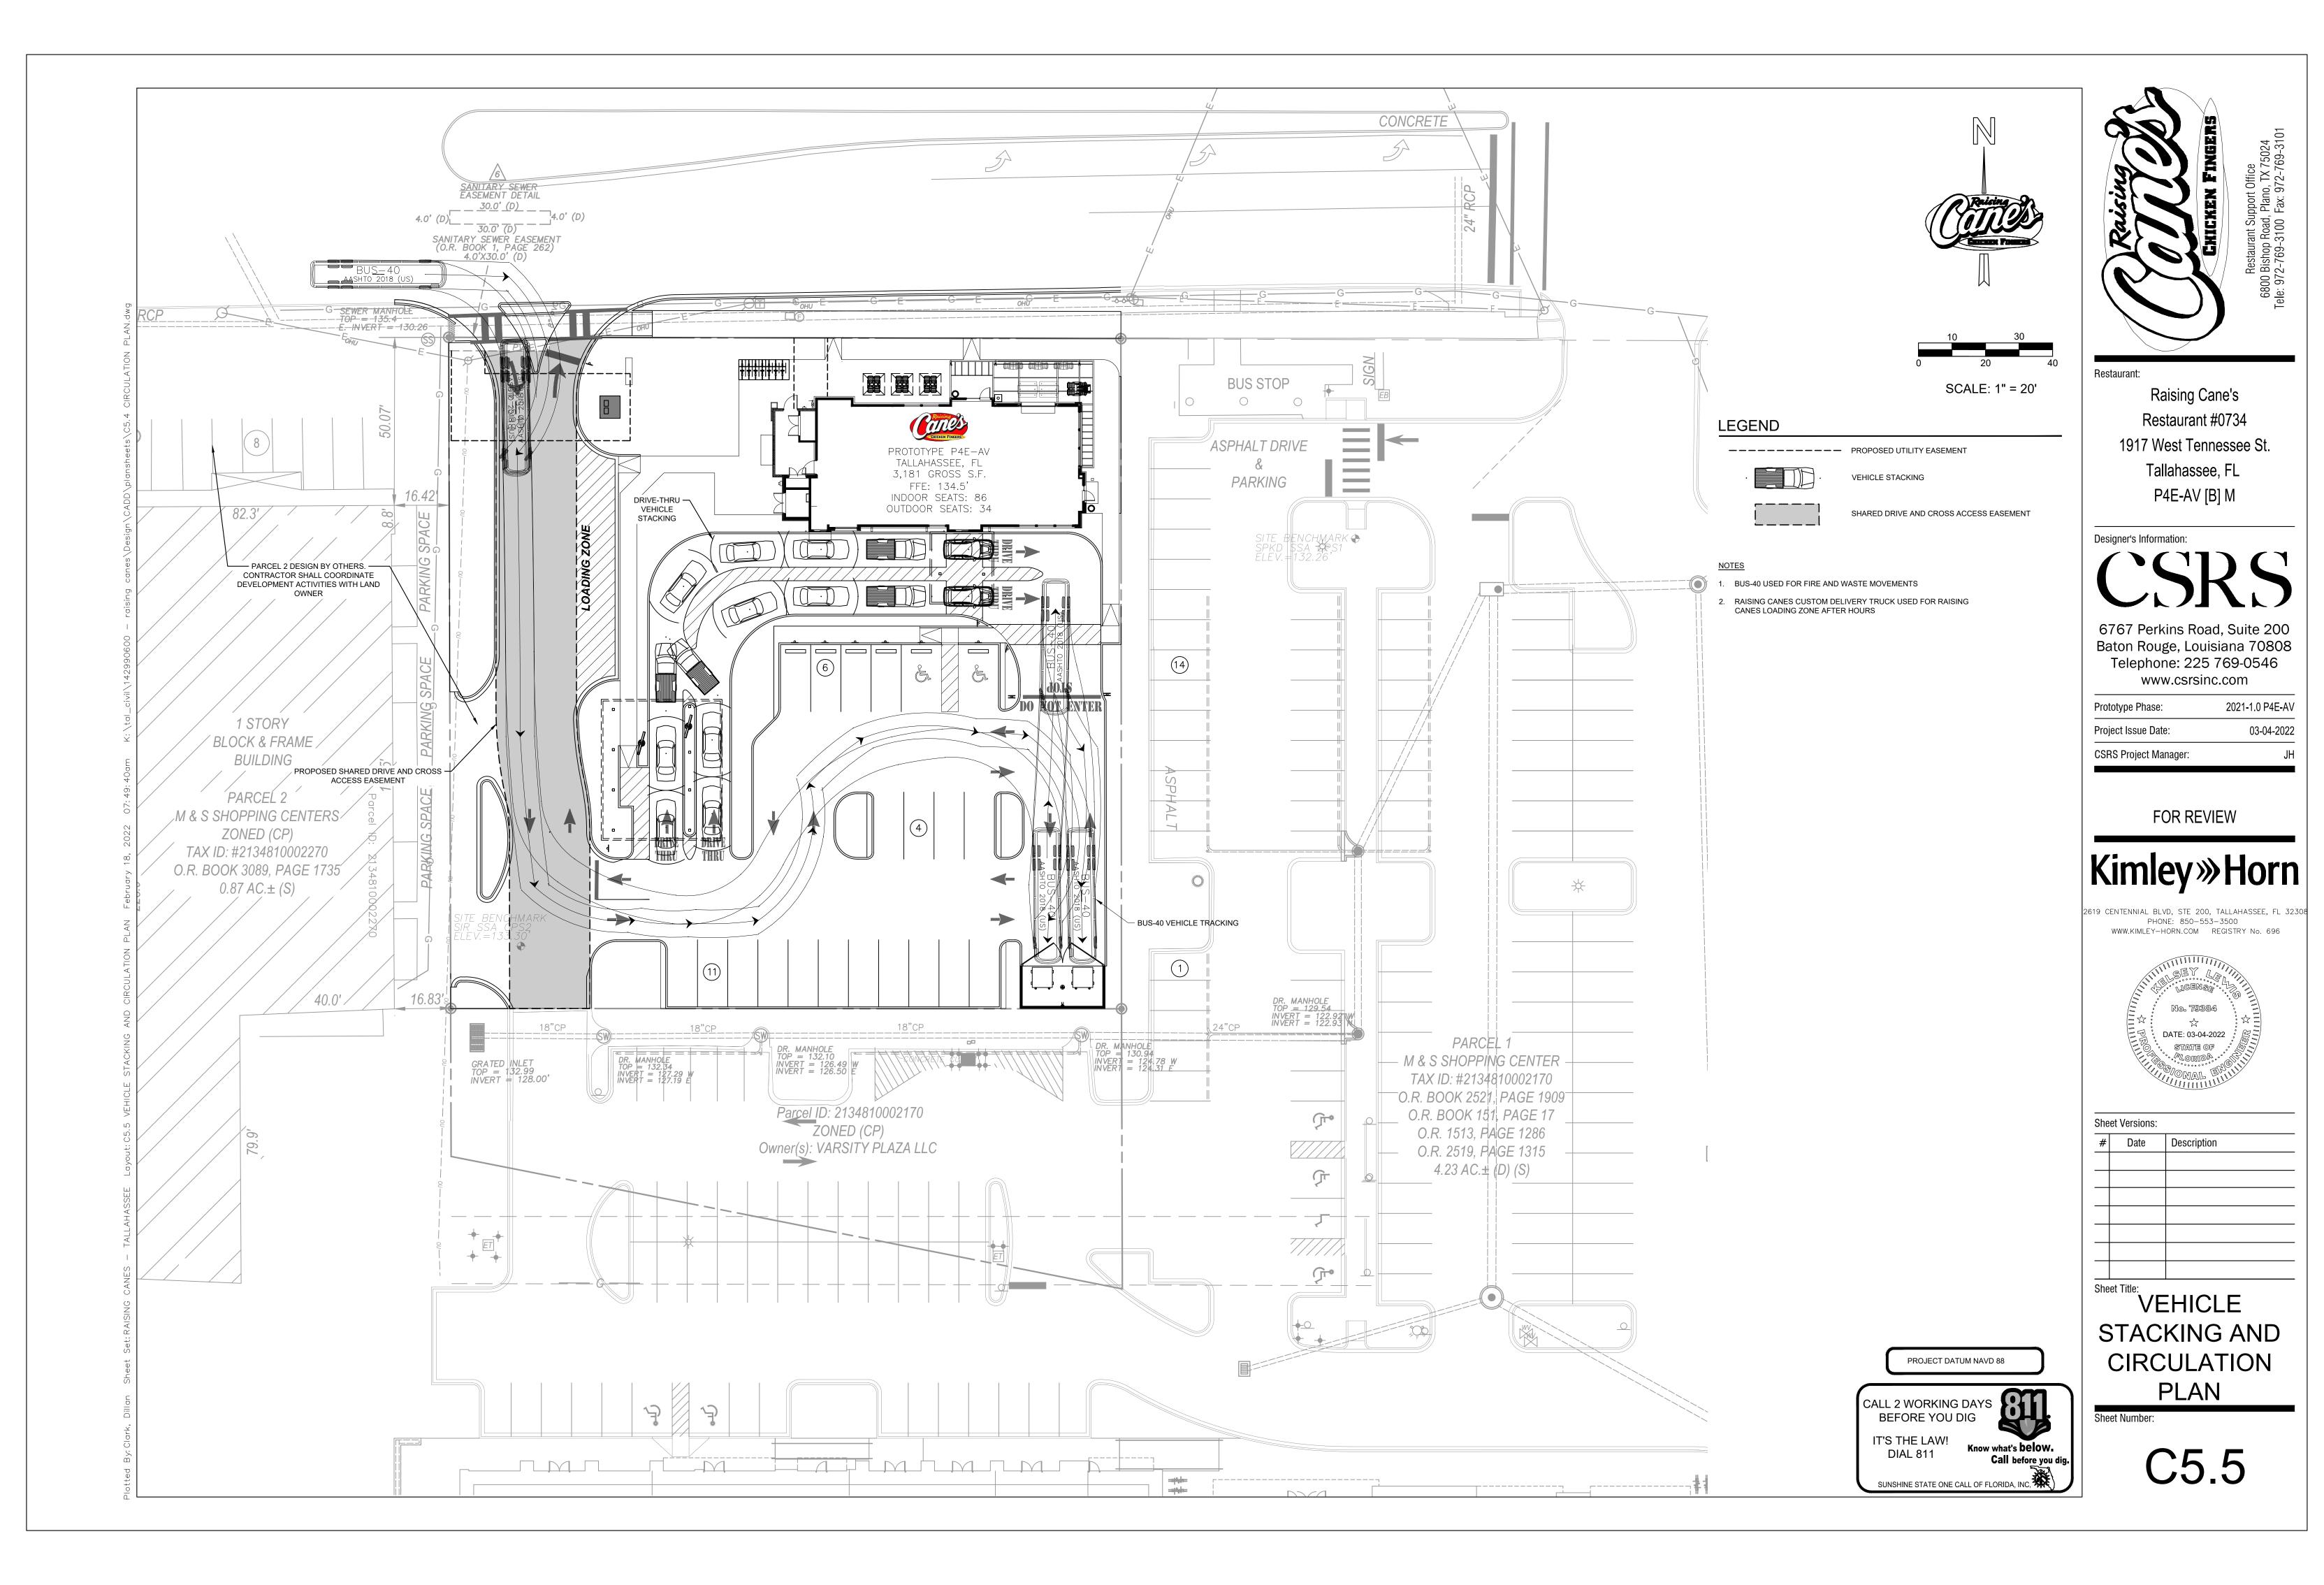

GRADING NOTES


- 1. ALL CONSTRUCTION TO BE IN ACCORDANCE WITH THESE PLANS AND THE CITY OF TALLAHASSEE STANDARDS AND
- PRIOR TO STARTING CONSTRUCTION, THE CONTRACTOR SHALL MAKE CERTAIN THAT ALL REQUIRED PERMITS AND APPROVALS HAVE BEEN OBTAINED. NO CONSTRUCTION OR FABRICATION SHALL BEGIN UNTIL THE CONTRACTOR HAS RECEIVED AND THOROUGHLY REVIEWED ALL PLANS AND OTHER DOCUMENTS APPROVED BY ALL OF THE PERMITTING
- THE GENERAL CONTRACTOR AND ALL SUB-CONTRACTORS SHALL VERIFY THE SUITABILITY OF ALL EXISTING AND PROPOSED SITE CONDITIONS INCLUDING GRADES AND DIMENSIONS BEFORE COMMENCEMENT OF ANY CONSTRUCTION. THE ENGINEER DRAINAGE ARE ACCEPTABLE, IF NECESSARY, UPON PRIOR APPROVAL OF ENGINEER. PAVING INSTALLED SHALL "FLUSH OUT" AT ANY JUNCTURE WITH EXISTING PAVING.
- ON THESE PLANS IS BASED ON RECORDS OF THE VARIOUS UTILITY COMPANIES, AND WHERE POSSIBLE, MEASUREMENTS AKEN IN THE FIELD. THE INFORMATION IS NOT TO BE RELIED ON AS BEING EXACT OR COMPLETE. THE CONTRACTOR MUST CALL THE APPROPRIATE UTILITY COMPANIES AT LEAST 72 HOURS BEFORE ANY EXCAVATION TO REQUEST EXACT FIELD LOCATION OF UTILITIES. IT SHALL BE THE RESPONSIBILITY OF THE CONTRACTOR TO RELOCATE ALL EXISTING UTILITIES WHICH CONFLICT WITH THE PROPOSED IMPROVEMENTS SHOWN ON THE PLANS.
- ALL CUT OR FILL SLOPES SHALL BE 4:1 OR FLATTER UNLESS OTHERWISE NOTED.
- 6. CONTRACTOR SHALL ADJUST AND/OR CUT EXISTING PAVEMENT AS NECESSARY TO ASSURE A SMOOTH FIT AND CONTINUOUS
- 7. CONTRACTOR SHALL ASSURE POSITIVE DRAINAGE AWAY FROM BUILDINGS FOR ALL NATURAL AND PAVED AREAS.
- TOPOGRAPHIC INFORMATION IS TAKEN FROM A TOPOGRAPHIC SURVEY BY LAND SURVEYORS. IF THE CONTRACTOR DOES NOT ACCEPT EXISTING TOPOGRAPHY AS SHOWN ON THE PLANS, WITHOUT EXCEPTION, THEN THE CONTRACTOR SHALL SUPPLY, AT THEIR EXPENSE, A TOPOGRAPHIC SURVEY BY A REGISTERED LAND SURVEYOR TO THE OWNER FOR REVIEW.
- 9. CONTRACTOR SHALL REFER TO ARCHITECTURAL PLANS FOR EXACT BUILDING FOOTPRINT DIMENSIONS.
- 10. CONTRACTOR SHALL REFER TO FINAL GEOTECH REPORT FOR BUILDING SUBGRADE AND SITE PREPARATION
- 11. CONTRACTOR SHALL ADJUST EXISTING VALVES, MANHOLE RIMS, ETC. AS NECESSARY TO MATCH FINISHED GRADE.
- 12. ALL ELEVATIONS ARE TOP OF PAVEMENT UNLESS NOTED OTHERWISE. TO GET TOP OF CURB ELEVATIONS ADD 6" TO THE
- 13. GRADING FOR ALL SIDEWALKS AND ACCESSIBLE ROUTES INCLUDING CROSSING DRIVEWAYS SHALL CONFORM TO ADA STANDARDS. SLOPES SHALL NOT EXCEED 5% LONGITUDINAL SLOPE OR 2% CROSS SLOPE. SIDEWALK ACCESS TO EXTERNAL BUILDING DOORS SHALL BE ADA COMPLIANT. CONTRACTOR SHALL NOTIFY ENGINEER IMMEDIATELY IF ADA CRITERIA
- 14. ANY PROPOSED CONTOURS SHOWN ARE APPROXIMATE. PROPOSED SPOT ELEVATIONS AND DESIGNATED GRADIENT ARE TO BE USED IN THE EVENT OF ANY DISCREPANCIES.
- 15. REFER TO EROSION CONTROL PLAN FOR EROSION CONTROL DEVICES TO BE INSTALLED PRIOR TO COMMENCING GRADING
- 16. ALL FILL TO BE PLACED SHALL BE IN ACCORDANCE WITH THE CURRENT APPLICABLE GEOTECHNICAL REPORT RECOMMENDATIONS.


Please incorporate and prominently display the following contractor notice on all site plans and environmental plans. This notice is provided to the contractor and owner to advise them of their ultimate responsibility of compliance with Florida Accessibility Code (aka Handicap Code).

CONTRACTOR NOTICE 2020 (effective December 31, 2020)

The Contractor & Owner will be held accountable during construction for all site improvements. Compliance with Florida Statutes 553.5041 (F.S.), and the 2020 Florida Building Code, Accessibility, 7th Edition (FBC-A), is mandatory. If non-compliant at final inspection, contractor will be required to modify construction to comply with F.S. and FBC-A. The following items take precedence and supersede other site details on drawings:

- 1. ACCESSIBLE PARKING spaces shall be located on an accessible route no less than 44" wide so that users will not be compelled to walk or wheel behind parked vehicles except behind his or her own vehicle. §208.1 and §502.3, FBC-A and F.S. 553.5041.
- 2. ACCESSIBLE PARKING spaces and access aisles serving a particular building shall be located on the shortest accessible route from the accessible (H/C) parking to an accessible entrance. §208.3.1 FBC-A and F.S. 553.5041(5)(b).
- 3. ACCESSIBLE PARKING spaces shall be 12' wide, and outlined with blue paint. §502.2 and §502.6, FBC-A
- 4. ACCESS AISLES required adjacent to parking spaces shall be 5' wide with diagonal striping. §502., FBC-A 5. ACCESSIBLE PARKING and access aisles shall be level (not to exceed 1:48) on a stable, firm & slip resistant surface. Re: §302.1, §502.3. FBC-A
- 6. ACCESSIBLE PARKING signs shall be EDOT approved and shall read 'PARKING BY DISABLED PERMIT ONLY' and shall indicate a \$250 fine for Install signs a minimum 60" (inches) from the ground to the bottom of the sign(s). Re: §502.6 and F.S 553.5041.
- 7. CURB RAMPS shall not exceed 1:12 slope, and curb ramp flares shall not exceed 1:10 slope. Curb ramps and flared sides shall not encroach upon parking spaces, access aisles, or vehicular traffic lanes. The counter slope of adjacent road surfaces & gutters shall not exceed 1:20. Re: §405.2, §406., FBC-A 8. CURB RAMPS shall have a landing with a minimum clear length of 36" shall be located at the top side of each curb ramp, a clear width at least as wide as the curb ramp (excluding flared sides) leading to it. Exception: for alterations, where there is no landing, curb ramp flares shall be provided, and shall not be steeper than
- 9. ALL RAMPS with a rise greater than 6" shall provide edge protection complying with §405.9 FACBC. Ramps shall have 60" min level landings at the top & bottom. Re: §405.7. FBC-A.
- 10. ALL RAMPS with a rise greater than 6" shall have handrails on both sides with 12" horizontal extensions at the top & bottom of the ramp. Re: §1010.9 FBC-B (Florida Building Code - Building) and §505.10 FBC-A.
- ACCESSIBLE ROUTES to "main entry" from an accessible parking space, and from the "public way", shall not exceed 1:20 slope (unless ramps, handrails
- with proper extensions are provided) with cross slope not in excess of 1:48. Re: \$206, \$402 and \$403., FBC-A. 12. *Connect buildings within the same site with an accessible route which shall not exceed 1:20 slope (unless ramps and handrails are provided) and a maximum
- cross slope of 1:48. Re: §206 FBC-A. * EXCEPTION: An accessible route shall not be required between accessible buildings, accessible facilities, accessible elements, and accessible spaces if the

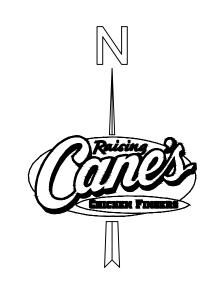

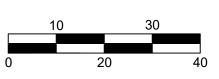


SCALE: 1" = 20'

LEGEND

PROPERTY LINE ---- 24 ---- EXISTING CONTOUR PROPOSED CONTOUR PROPOSED UNDERGROUND STORMWATER FACILITY PROPOSED FLOW ARROW WITH SLOPE PROPOSED SPOT ELEVATION EXISTING STORM SEWER PROPOSED STORM SEWER PROPOSED STORM INLET PROPOSED ACCESS TO UNDERGROUND FACILITY TOP OF CURB TOP OF PAVEMENT TOP OF SLAB (DUMPSTER PAD) TOP OF SIDEWALK MATCH EXISTING ELEVATION MATCH EXISTING SURVEYED ELEVATION

TOP OF GRATE

HIGH POINT

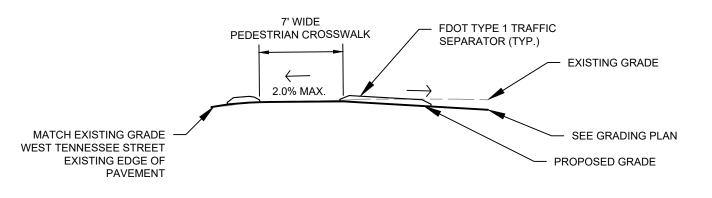

SECTION A-A TYPICAL DRIVEWAY SECTION

PROJECT DATUM NAVD 88

CALL 2 WORKING DAYS BEFORE YOU DIG IT'S THE LAW! **DIAL 811** Call before you dig. SUNSHINE STATE ONE CALL OF FLORIDA, INC.

Restaurant:

Raising Cane's Restaurant #0734 1917 West Tennessee St. Tallahassee, FL P4E-AV [B] M

Designer's Information:

6767 Perkins Road, Suite 200 Baton Rouge, Louisiana 70808 Telephone: 225 769-0546 www.csrsinc.com

2021-1.0 P4E-AV Prototype Phase: 03-04-2022 Project Issue Date: CSRS Project Manager:

FOR REVIEW


2619 CENTENNIAL BLVD, STE 200, TALLAHASSEE, FL 3230 PHONE: 850-553-3500



	et Versions:	
#	Date	Description
She	et Title:	

GRADING PLAN

Sheet Number:

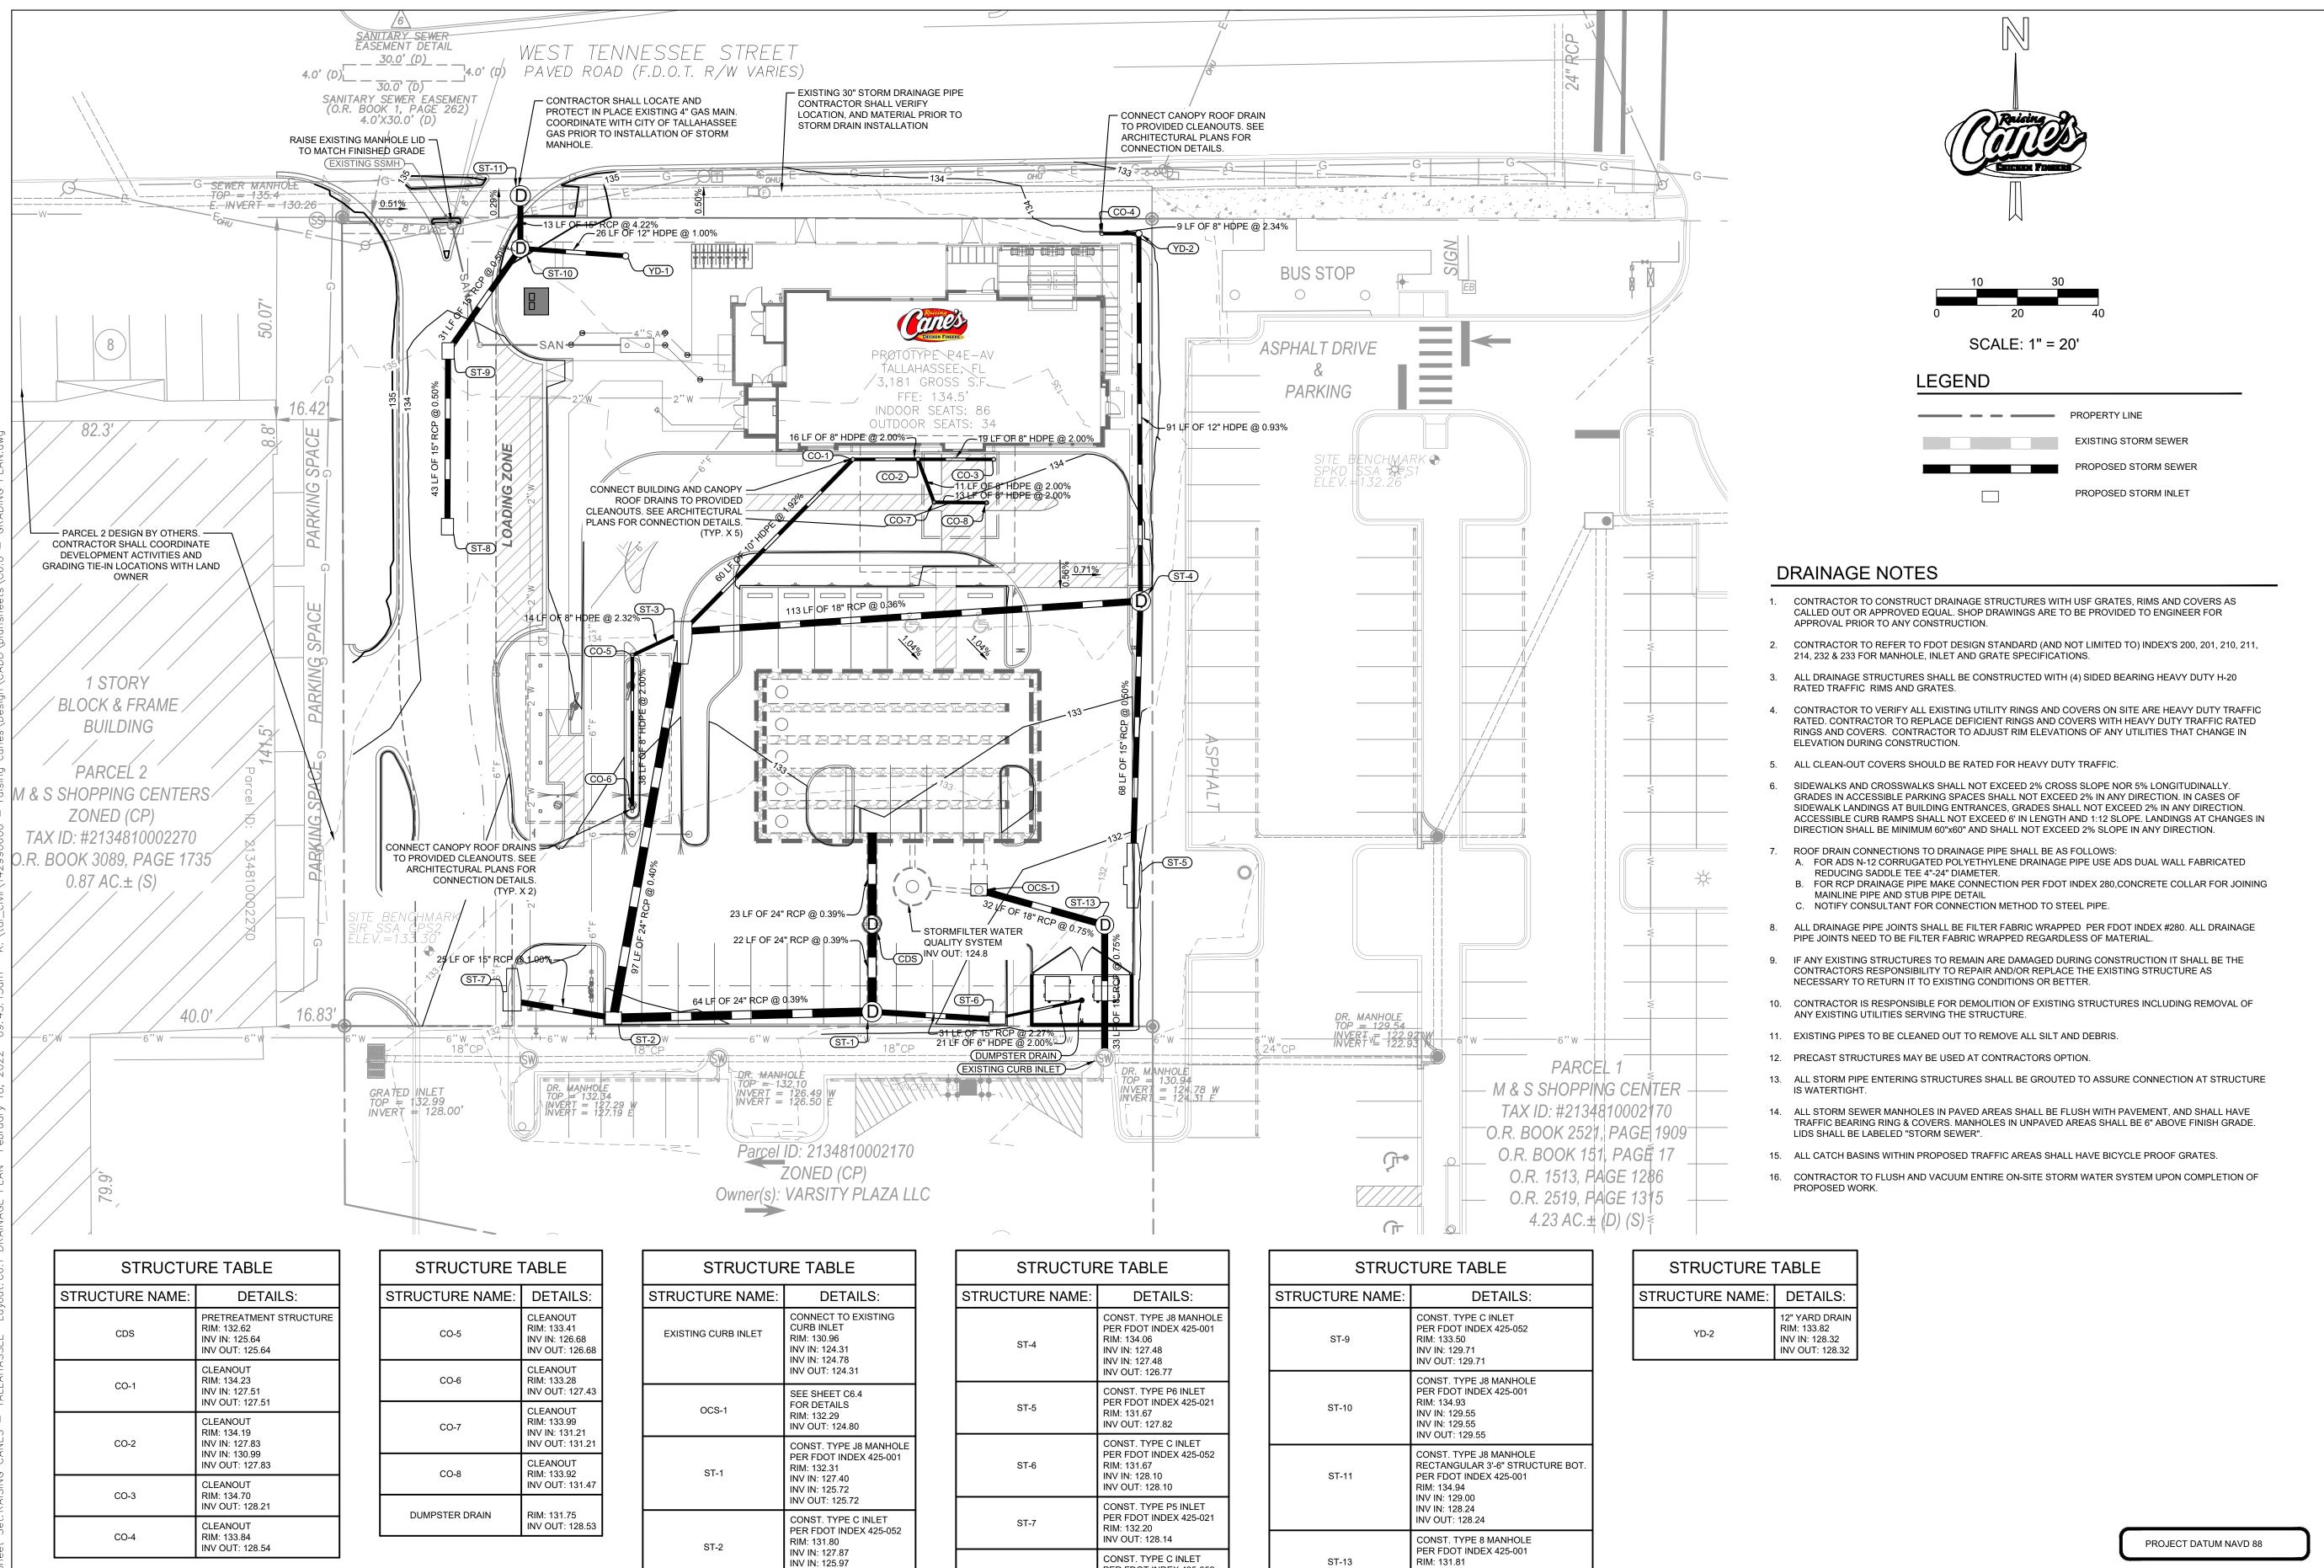

PER FDOT INDEX 425-052

RIM: 133.22

INV OUT: 129.92

ST-8

INV OUT: 125.97

RIM: 133 70

INV IN: 126.36 INV IN: 126.36

INV IN: 126.36

INV OUT: 126.36

ST-3

CONST. TYPE J5 INLET

PER FDOT INDEX 425-021

INV IN: 124.56

INV OUT: 124.56

12" YARD DRAIN

INV OUT: 129.81

RIM: 134.00

YD-1

Raising Exicken Fingers

Restaurant:

Raising Cane's
Restaurant #0734
1917 West Tennessee St.
Tallahassee, FL
P4E-AV [B] M

Designer's Information:

CSRS

6767 Perkins Road, Suite 200 Baton Rouge, Louisiana 70808 Telephone: 225 769-0546 www.csrsinc.com

Prototype Phase:	2021-1.0 P4E-AV
Project Issue Date:	03-04-2022
CSRS Project Manager:	JH

FOR REVIEW

Kimley» Horn

2619 CENTENNIAL BLVD, STE 200, TALLAHASSEE, FL 32308 PHONE: 850-553-3500



#	Date	Description

DRAINAGE PLAN

Sheet Number:

CALL 2 WORKING DAYS

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SUNSHINE STATE ONE CALL OF FLORIDA, INC.


Know what's **below.**

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IT'S THE LAW!

DIAL 811

C6.

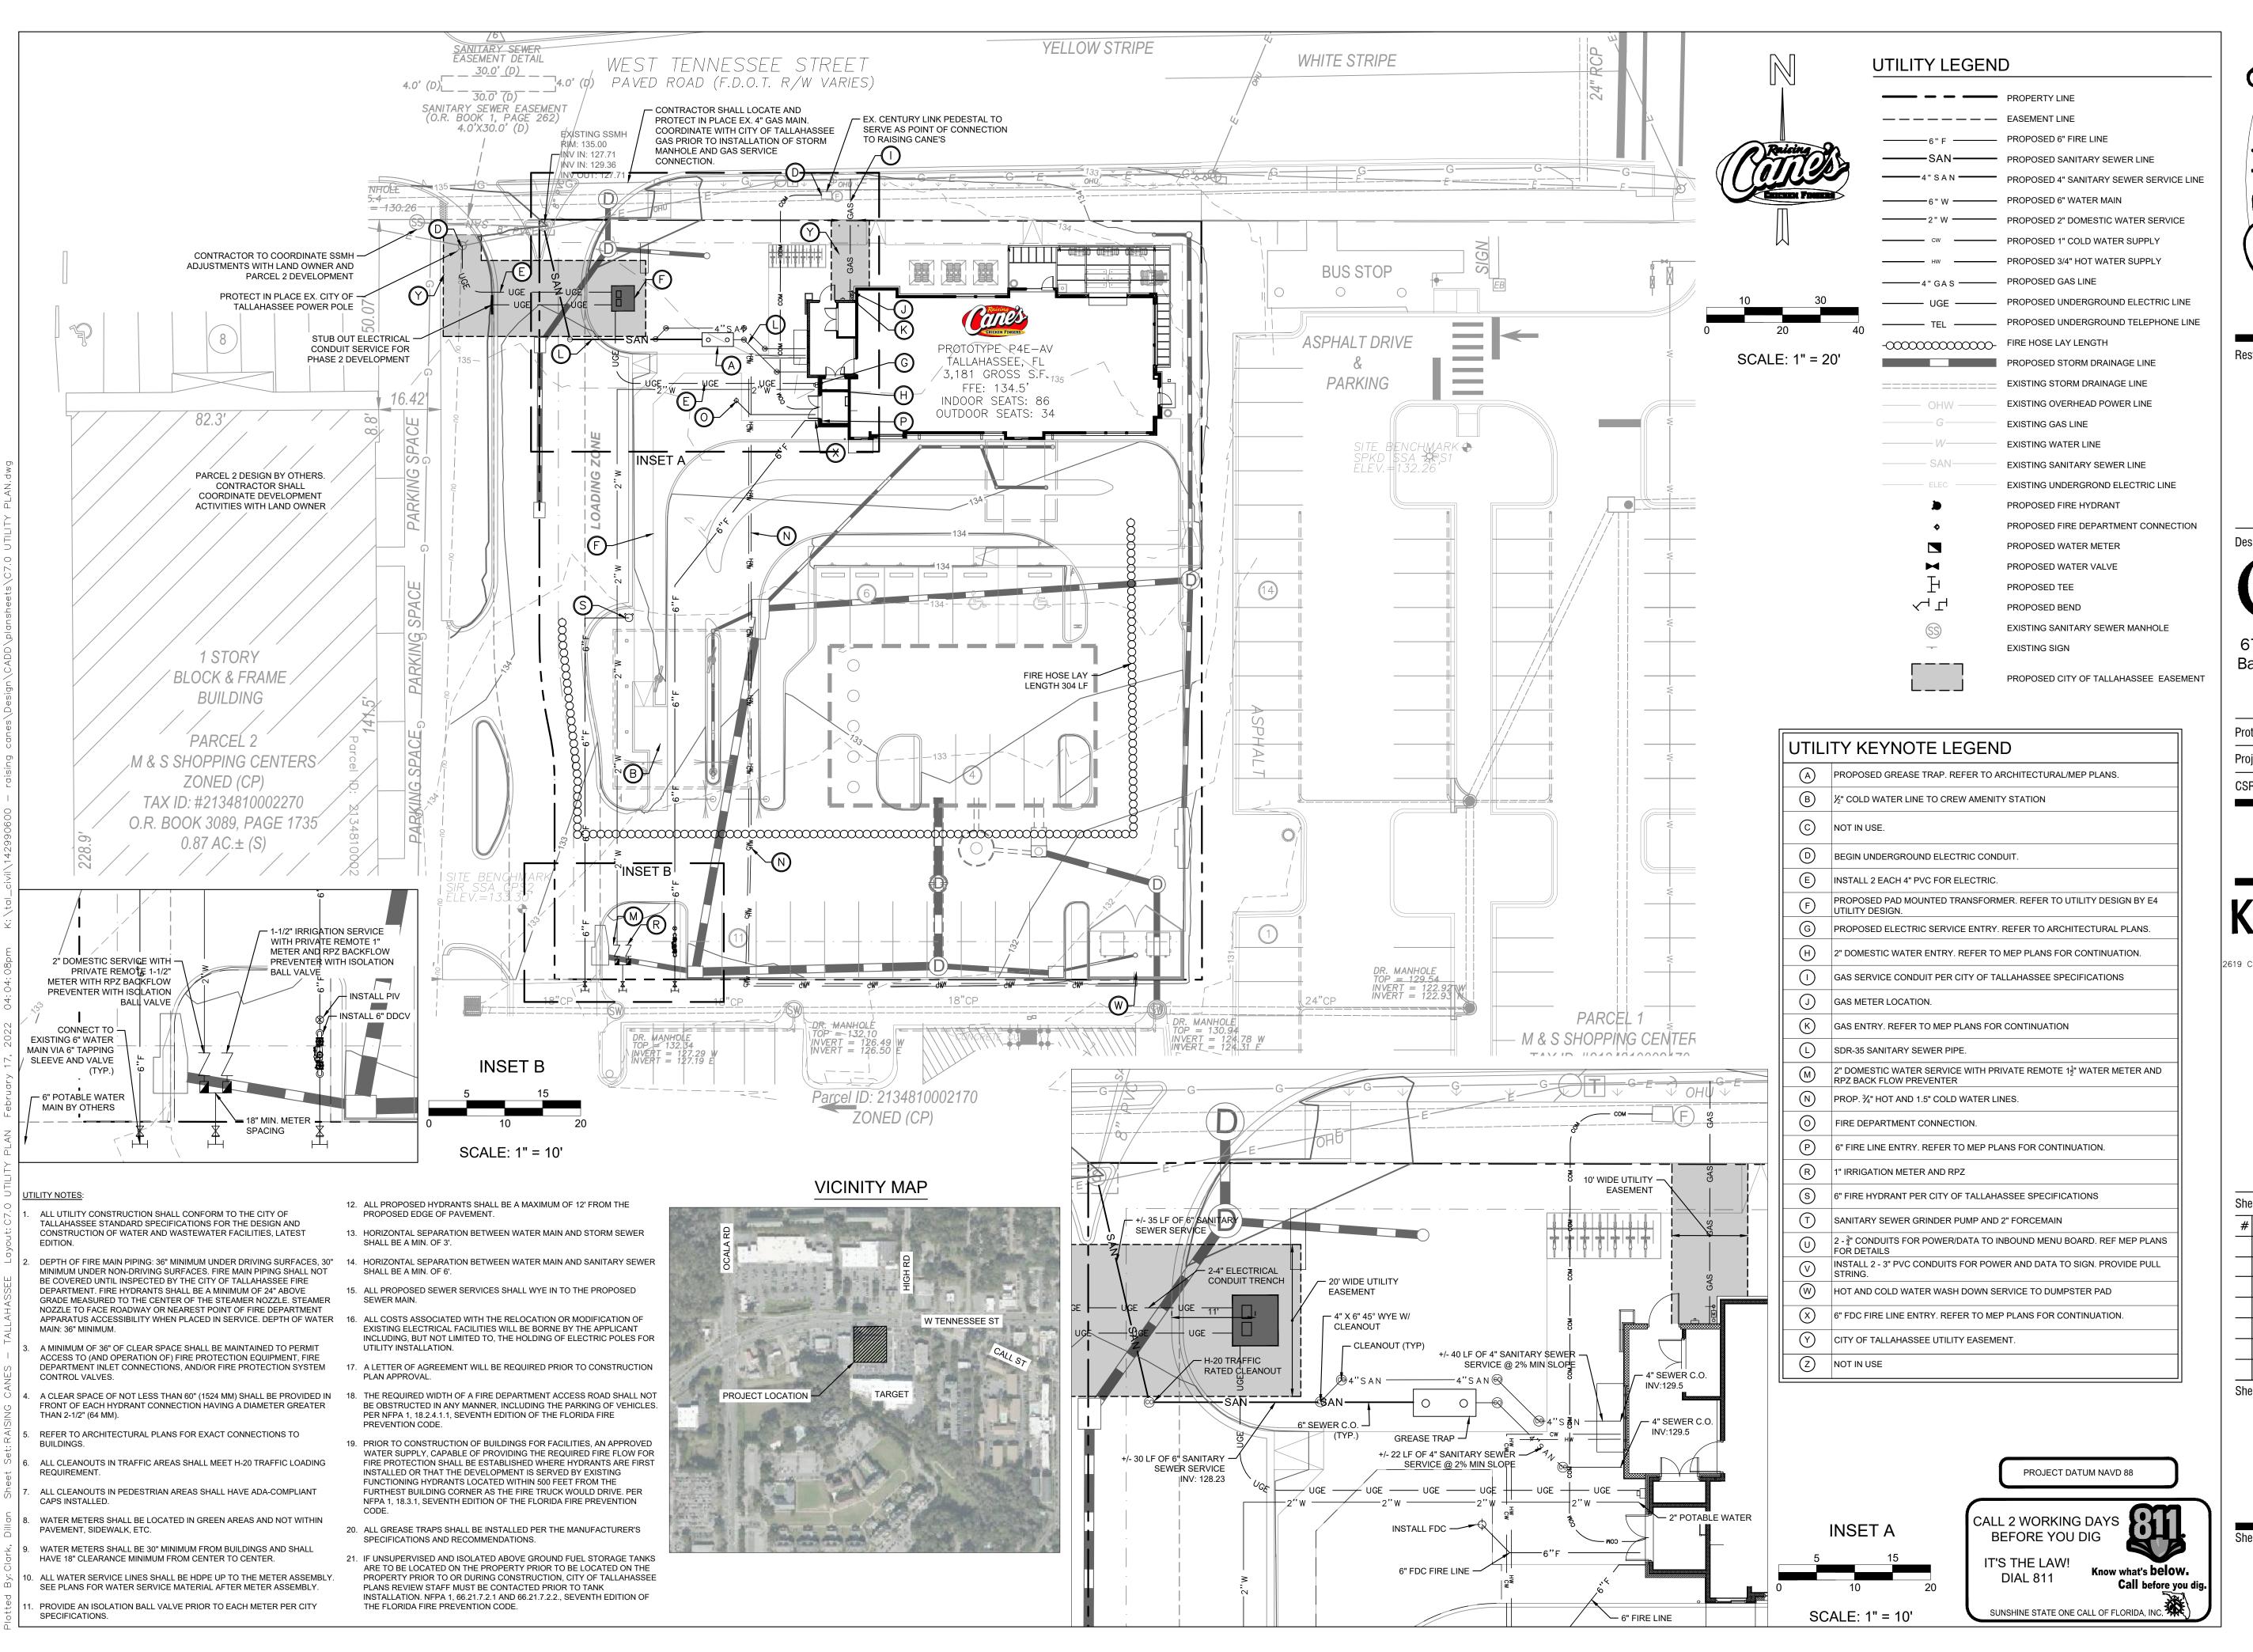

Raising CHICKEN FINGERS

Restaurant:

Raising Cane's
Restaurant #0734
1917 West Tennessee St.
Tallahassee, FL
P4E-AV [B] M

Designer's Information:

CSRS

6767 Perkins Road, Suite 200 Baton Rouge, Louisiana 70808 Telephone: 225 769-0546 www.csrsinc.com

Prototype Phase: 2021-1.0 P4E-AV

Project Issue Date: 03-04-2022

CSRS Project Manager: JH

FOR REVIEW

Kimley»Horn

2619 CENTENNIAL BLVD, STE 200, TALLAHASSEE, FL 3230 PHONE: 850-553-3500




#	Date	Description	

UTILITY PLAN

Sheet Number:

C7.0

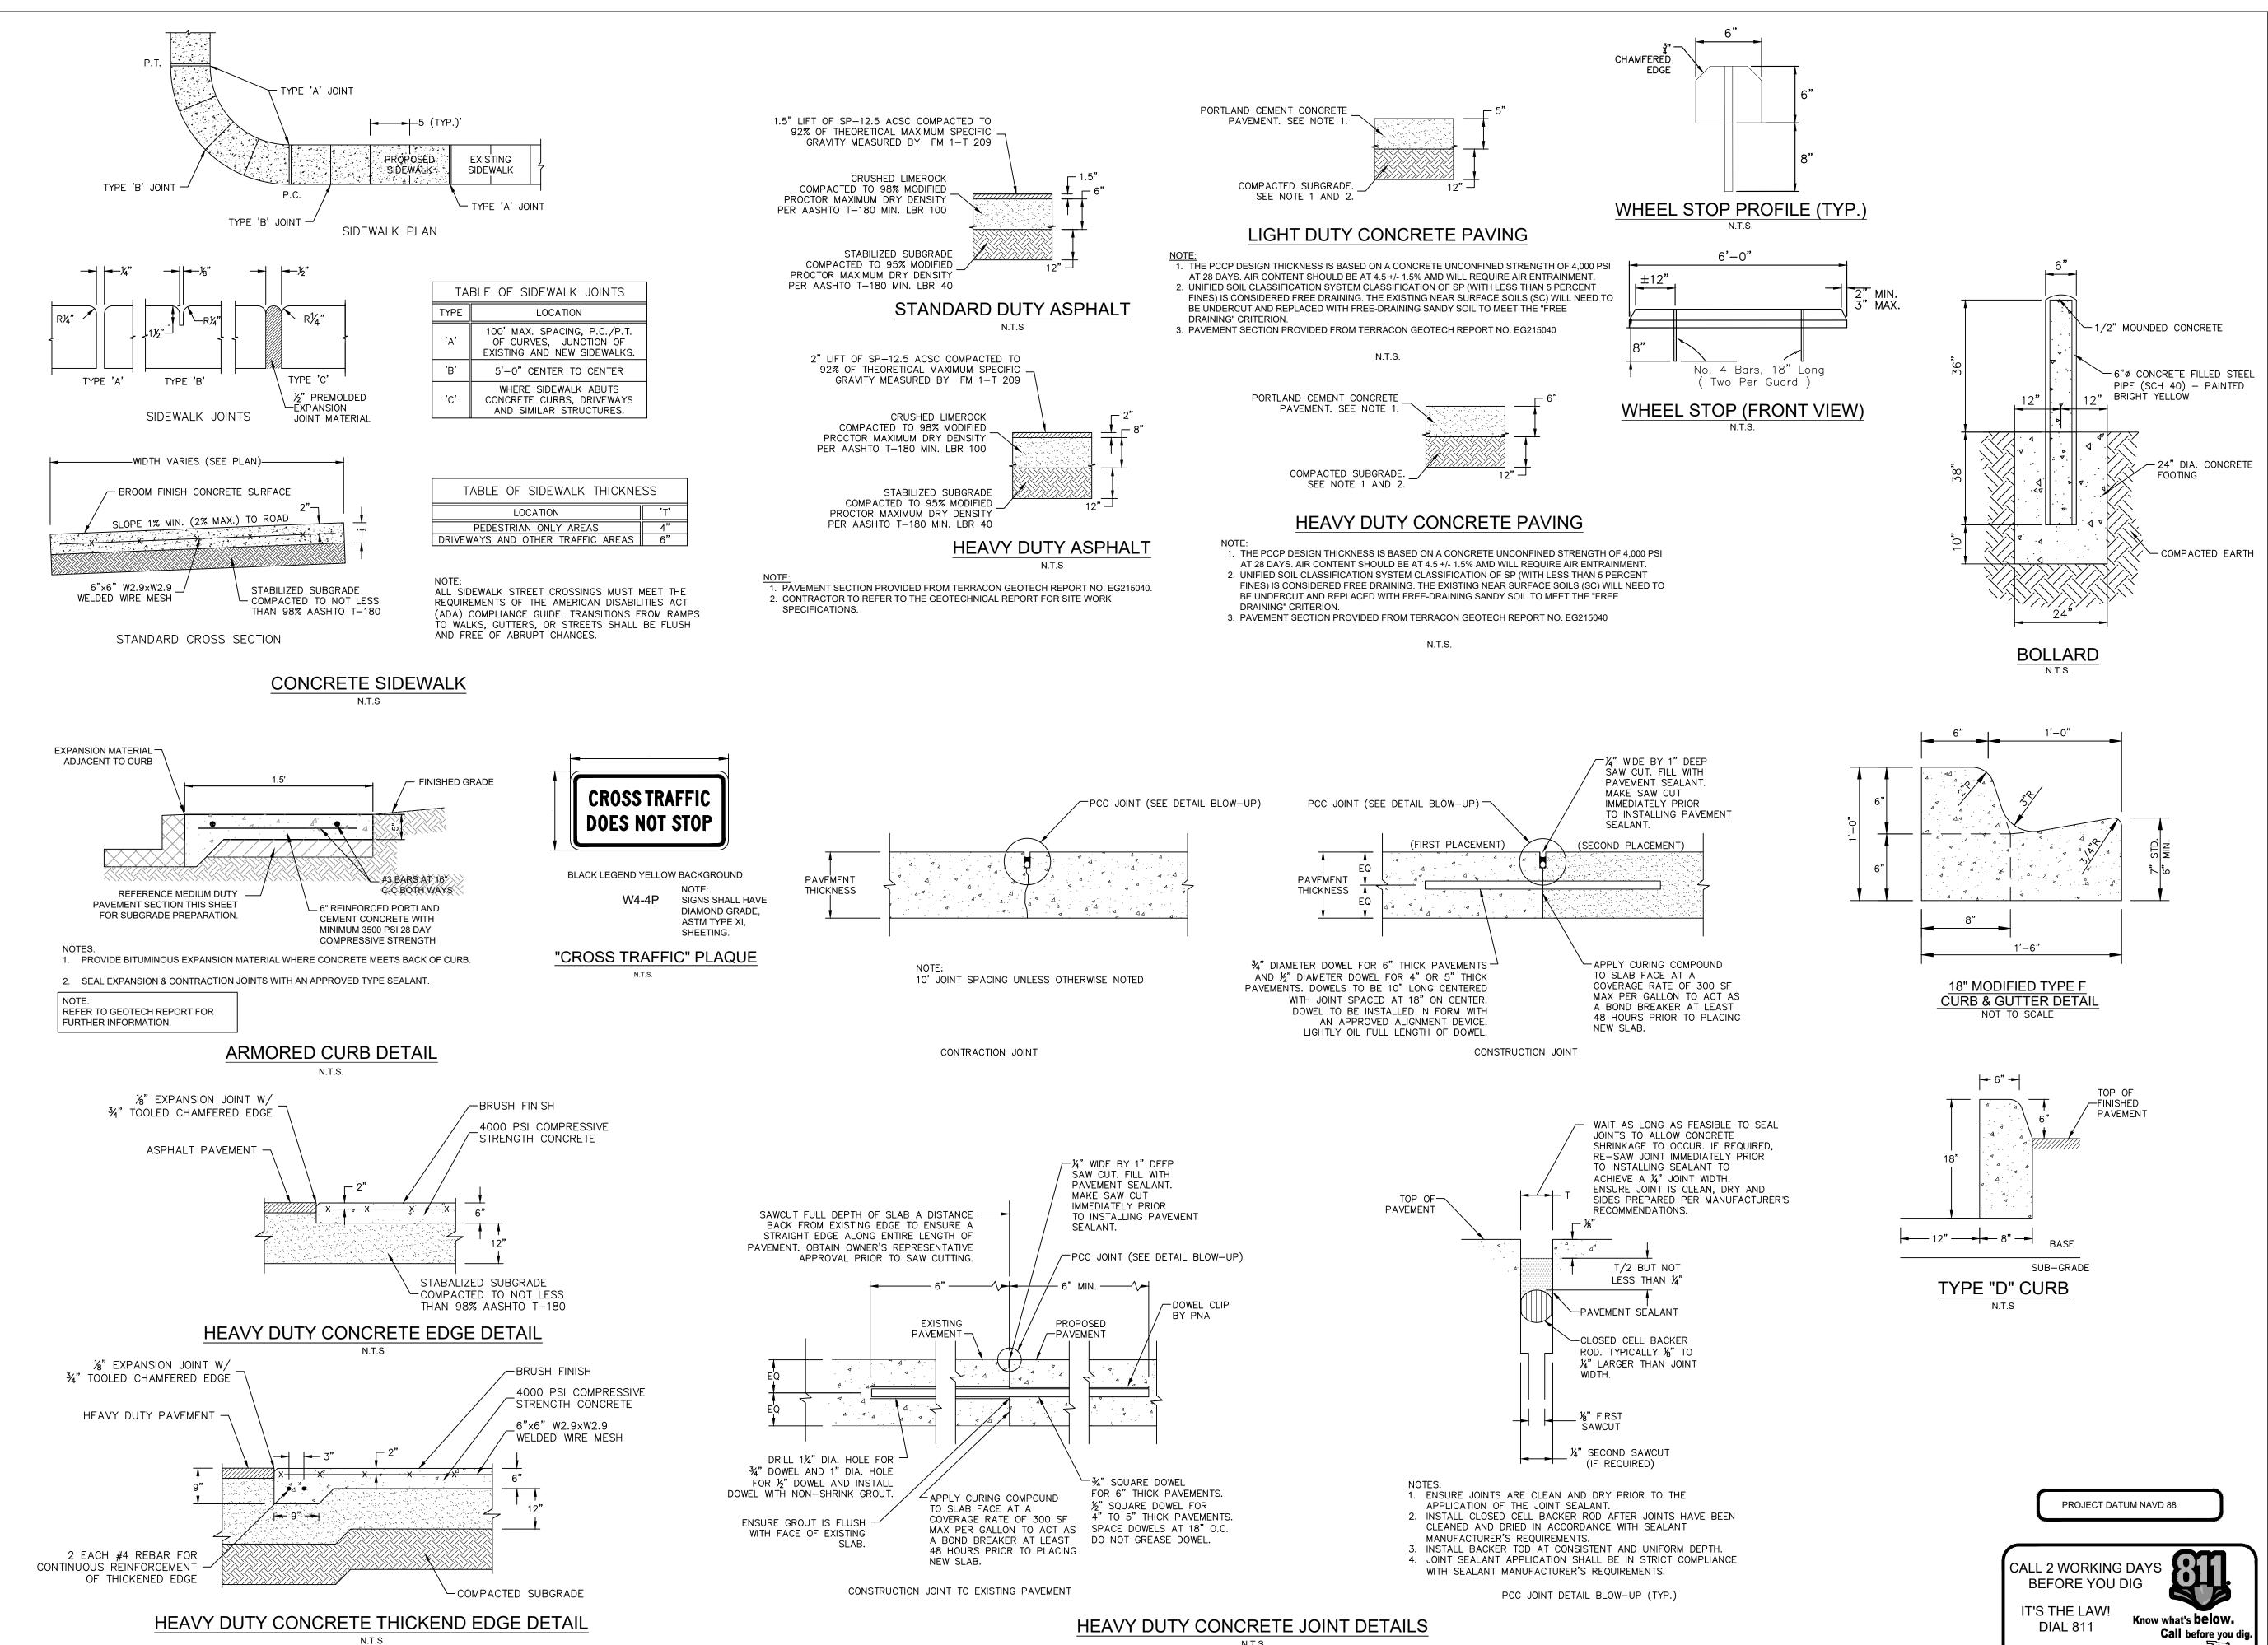

Restaurant Support Office 6800 Bishop Road, Plano, TX 75024
Tele: 972-769-3101

Restaurant:

Raising Cane's
Restaurant #0734
1917 West Tennessee St.
Tallahassee, FL
P4E-AV [B] M

Designer's Information:

CSRS


6767 Perkins Road, Suite 200 Baton Rouge, Louisiana 70808 Telephone: 225 769-0546 www.csrsinc.com

Prototype Phase:	2021-1.0 P4E-AV
Project Issue Date:	02-03-2022
CSRS Project Manager:	Jŀ

FOR REVIEW

Kimley » Horn

2619 CENTENNIAL BLVD, STE 200, TALLAHASSEE, FL 32308 PHONE: 850-553-3500

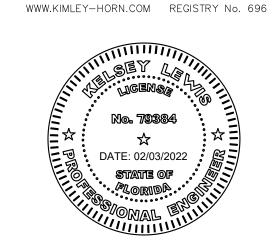


Sheet Versions:			
Date	Description		
	Date	Date Description	

CONSTRUCTION DETAILS

Sheet Number:

SUNSHINE STATE ONE CALL OF FLORIDA, INC.

C8.0

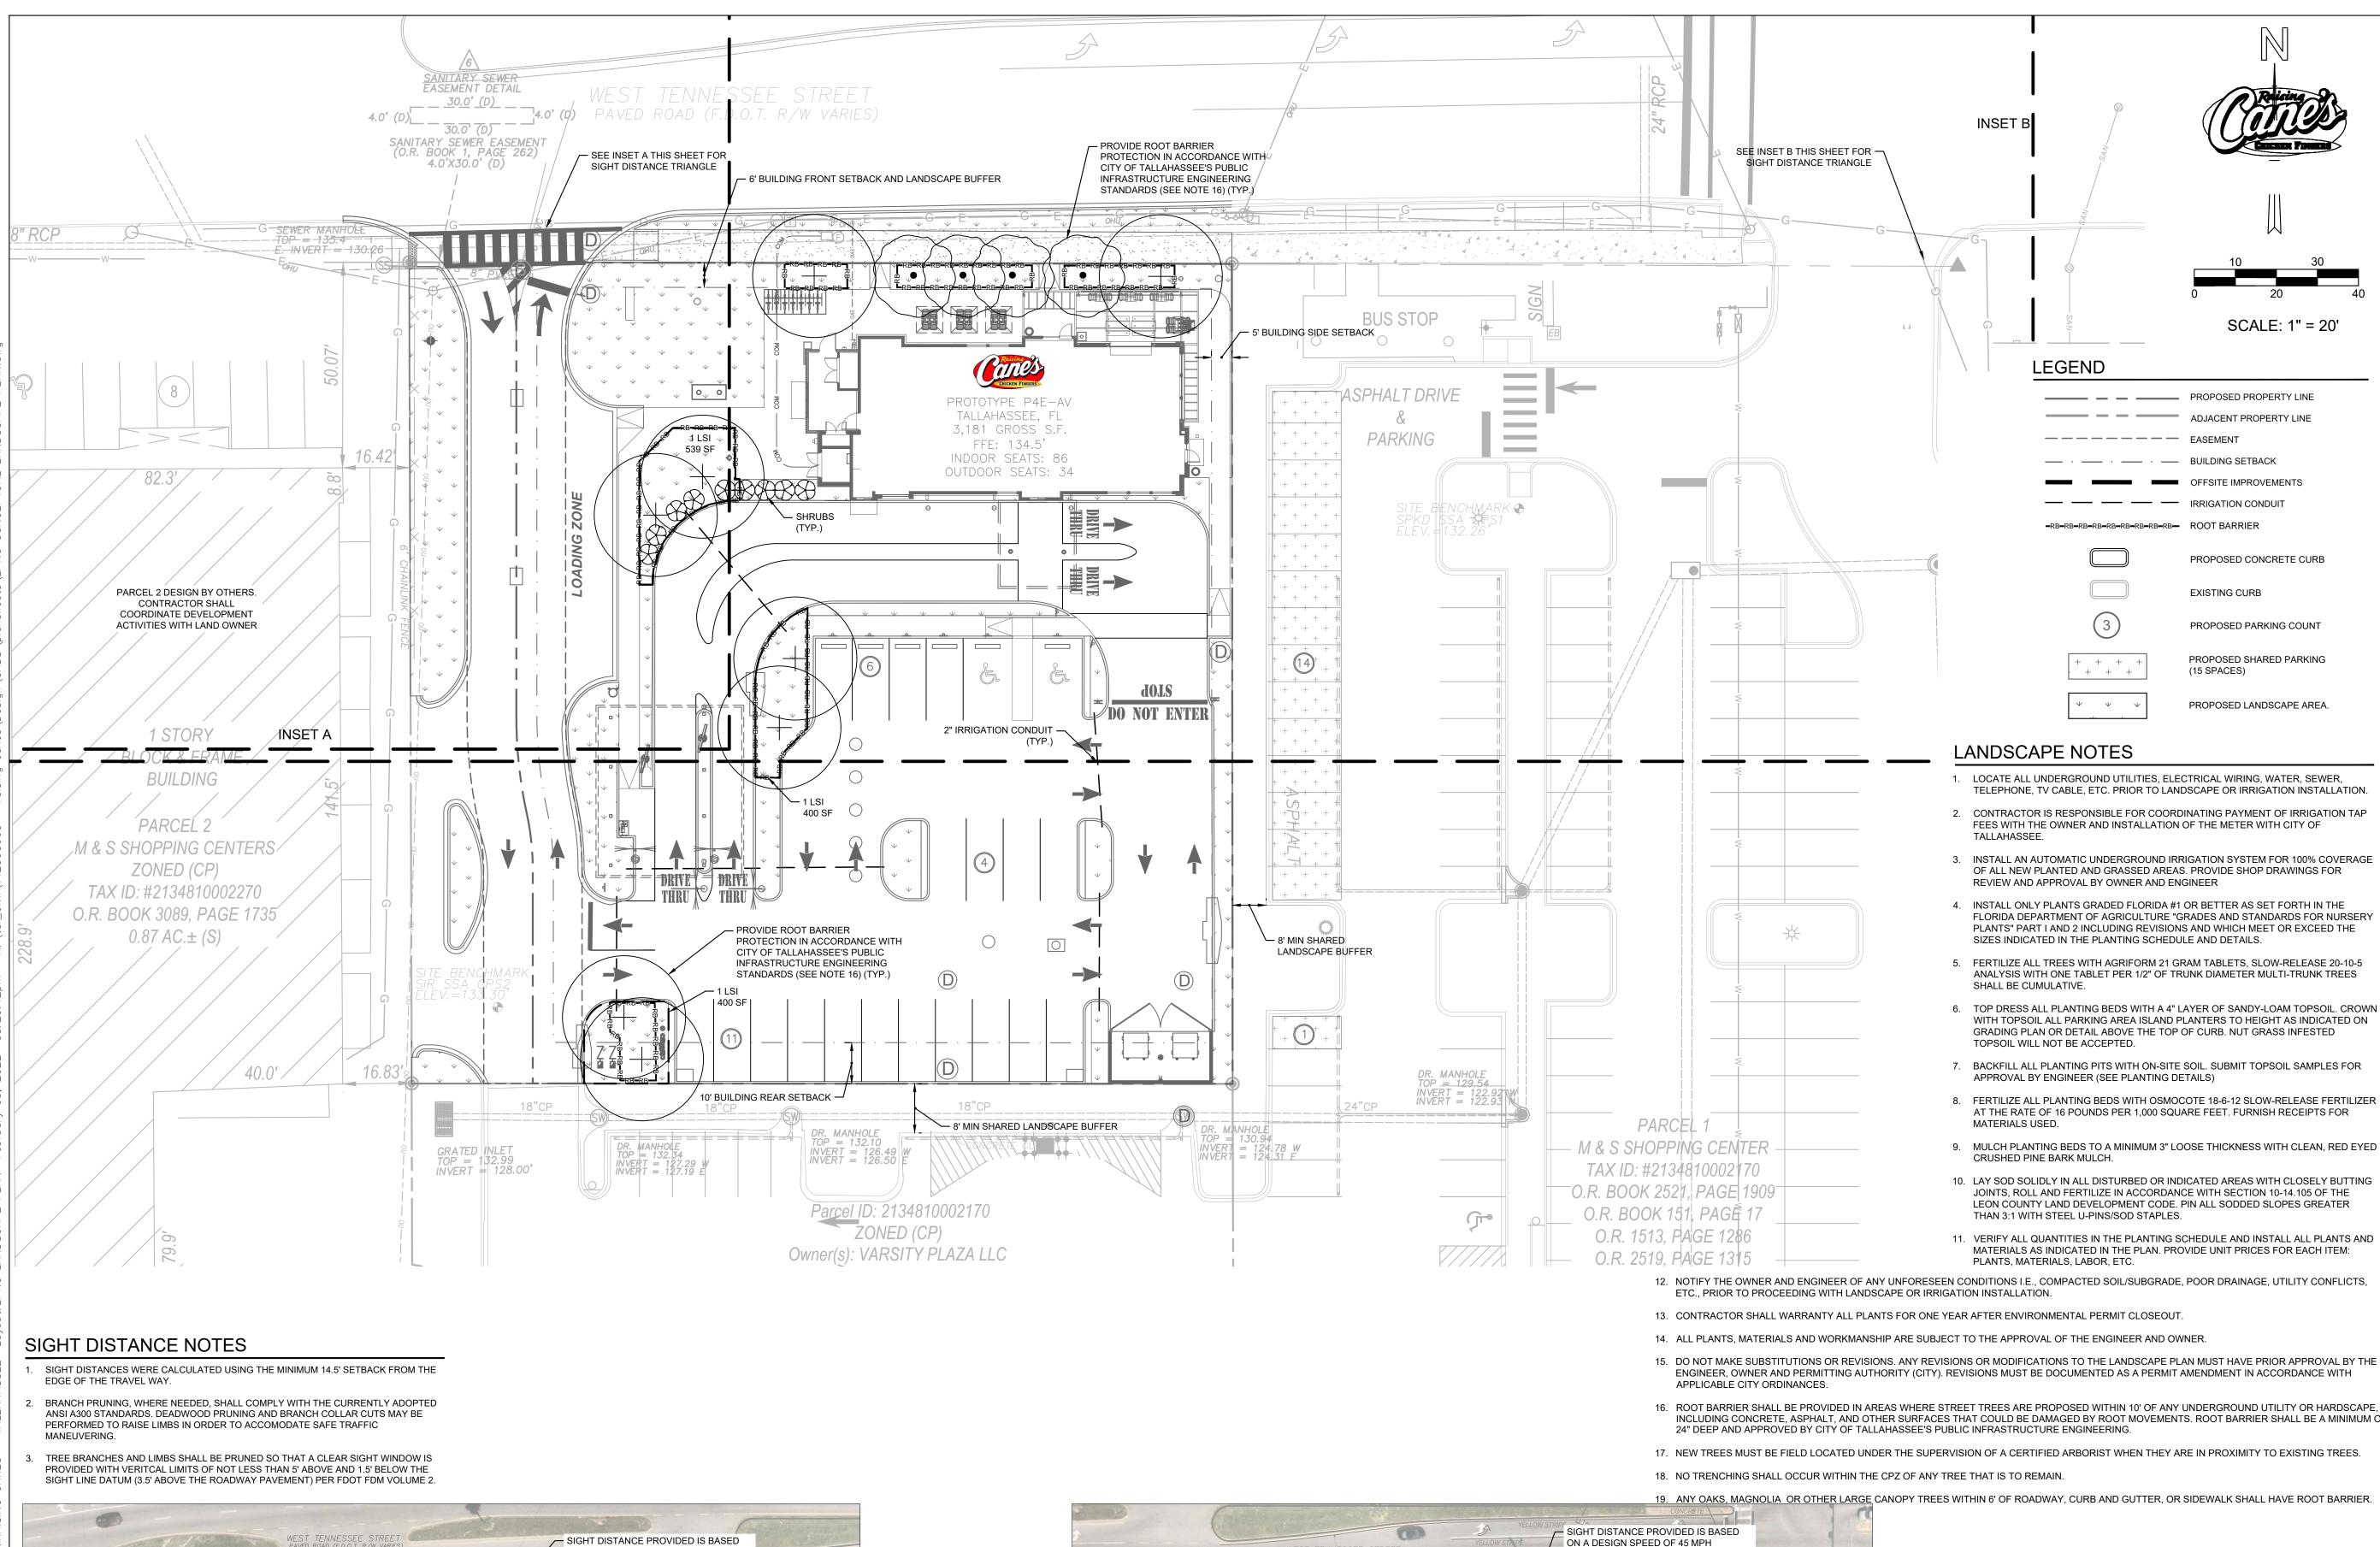

Restaurant:

SCALE: 1" = 20'

PROPOSED PROPERTY LINE

ADJACENT PROPERTY LINE

---- BUILDING SETBACK

— — IRRIGATION CONDUIT

OFFSITE IMPROVEMENTS

PROPOSED CONCRETE CURB

PROPOSED PARKING COUNT

PROPOSED SHARED PARKING

PROPOSED LANDSCAPE AREA.

EXISTING CURB

(15 SPACES)

LEGEND

Raising Cane's Restaurant #0734 1917 West Tennessee St. Tallahassee, FL P4E-AV [B] M


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6767 Perkins Road, Suite 200 Baton Rouge, Louisiana 70808 Telephone: 225 769-0546 www.csrsinc.com

	Prototype Phase:	2021-1.0 P4E-AV
ION. TAP	Project Issue Date:	02-03-2022
	CSRS Project Manager:	JH

FOR REVIEW

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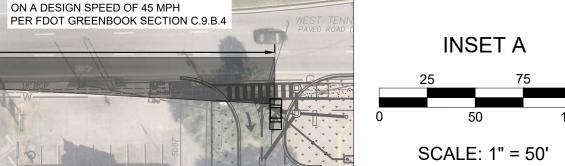


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	Sheet	Title	

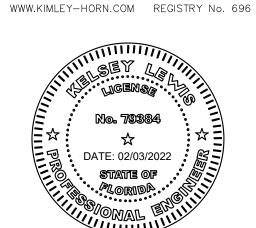CONCEPTUAL LANDSCAPE

Sheet Number:

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450' REQUIRED / 450' PROVIDED



INSET B SCALE: 1" = 50'

PROJECT DATUM NAVD 88 ALL 2 WORKING DAYS BEFORE YOU DIG IT'S THE LAW! Know what's **below**.

DIAL 811

SUNSHINE STATE ONE CALL OF FLORIDA, INC.